

# DESIGN & CONSTRUCTION GROUP THE GOVERNOR NELSON A. ROCKEFELLER EMPIRE STATE PLAZA ALBANY, NY 12242

#### ADDENDUM NO. 3 TO PROJECT NO. 47007

CONSTRUCTION WORK
PROVIDE EXTERIOR RENOVATIONS
BUILDING 102
MANHATTAN PYCHIATRIC CENTER
600 EAST 125<sup>TH</sup> STREET
NEW YORK, NY

June 20, 2025

**NOTE:** This Addendum forms a part of the Contract Documents. Insert it in the Project Manual. Acknowledge receipt of this Addendum in the space provided on the Bid Form.

#### **SPECIFICATIONS**

- 1. Page 230923 2, Change Paragraph 1.06 A. to Read:
  - "A. The existing Direct Digital Building Control System is Metasys by Johnson Controls. The Control sub-contractor shall thoroughly review as-built system prior to bid, propose and plan new work for integration. Contact Michael Bear, <a href="michael.s.baer@jci.com">michael.s.baer@jci.com</a>, (914) 275-2932 for information as need."
- 2. Page 283105 2, Change Paragraph 1.5 A. to Read:
  - "A. The existing Simplex 4100ES System operates as an integrated multiplexed protected premises fire alarm, monitoring and control system. The existing system is a One-Way Emergency Voice Alarm System with Two-Way Emergency Telephone Communication System. Johnson Controls Fire Protection contact is Anthony M. Porpora, anthony.porpora@jci.com, 347-371-2697.

#### **DRAWINGS**


- 3. Revised Drawings:
  - a. Drawing Nos. AD-100, AD-107, AD-110, AD-112, AD-114, AD-118, AD-120, AD-122, AD-124, A-100, A-106, A-108, A-112, A-122, A-200, A-202, A204, A-206, A-208, A-210, A-212, A-214, A-216, A-218, A-220, A-222, A-226, A-300, A-304, A-308, A-312, A-316, A-318, A-320 and E-701, noted "ADDENDUM #3" accompany this Addendum and supersede the same numbered originally issued drawings.

- 4. Drawing Nos. A-100 and A-200:
  - a. CONSTRUCTION NOTES Column, Change Note S-13 to Read:


"S-13 PROVIDE LAMP POST ('OURO' BY KIM LIGHTING, BASIS OF DESIGN) WITH 6'-0" H, 12" POURED CONCRETE PEDESTAL BASE, SEE DWGS. 1& 2/**A-502**. SEE ELECTRICAL DRAWINGS & SPECIFICATIONS FOR MORE DETAILS, ELECTRICAL DRAWINGS FOR POWER CONNECTION"

### **END OF ADDENDUM**

Brady M. Sherlock, P.E. Director, Division of Design Design & Construction

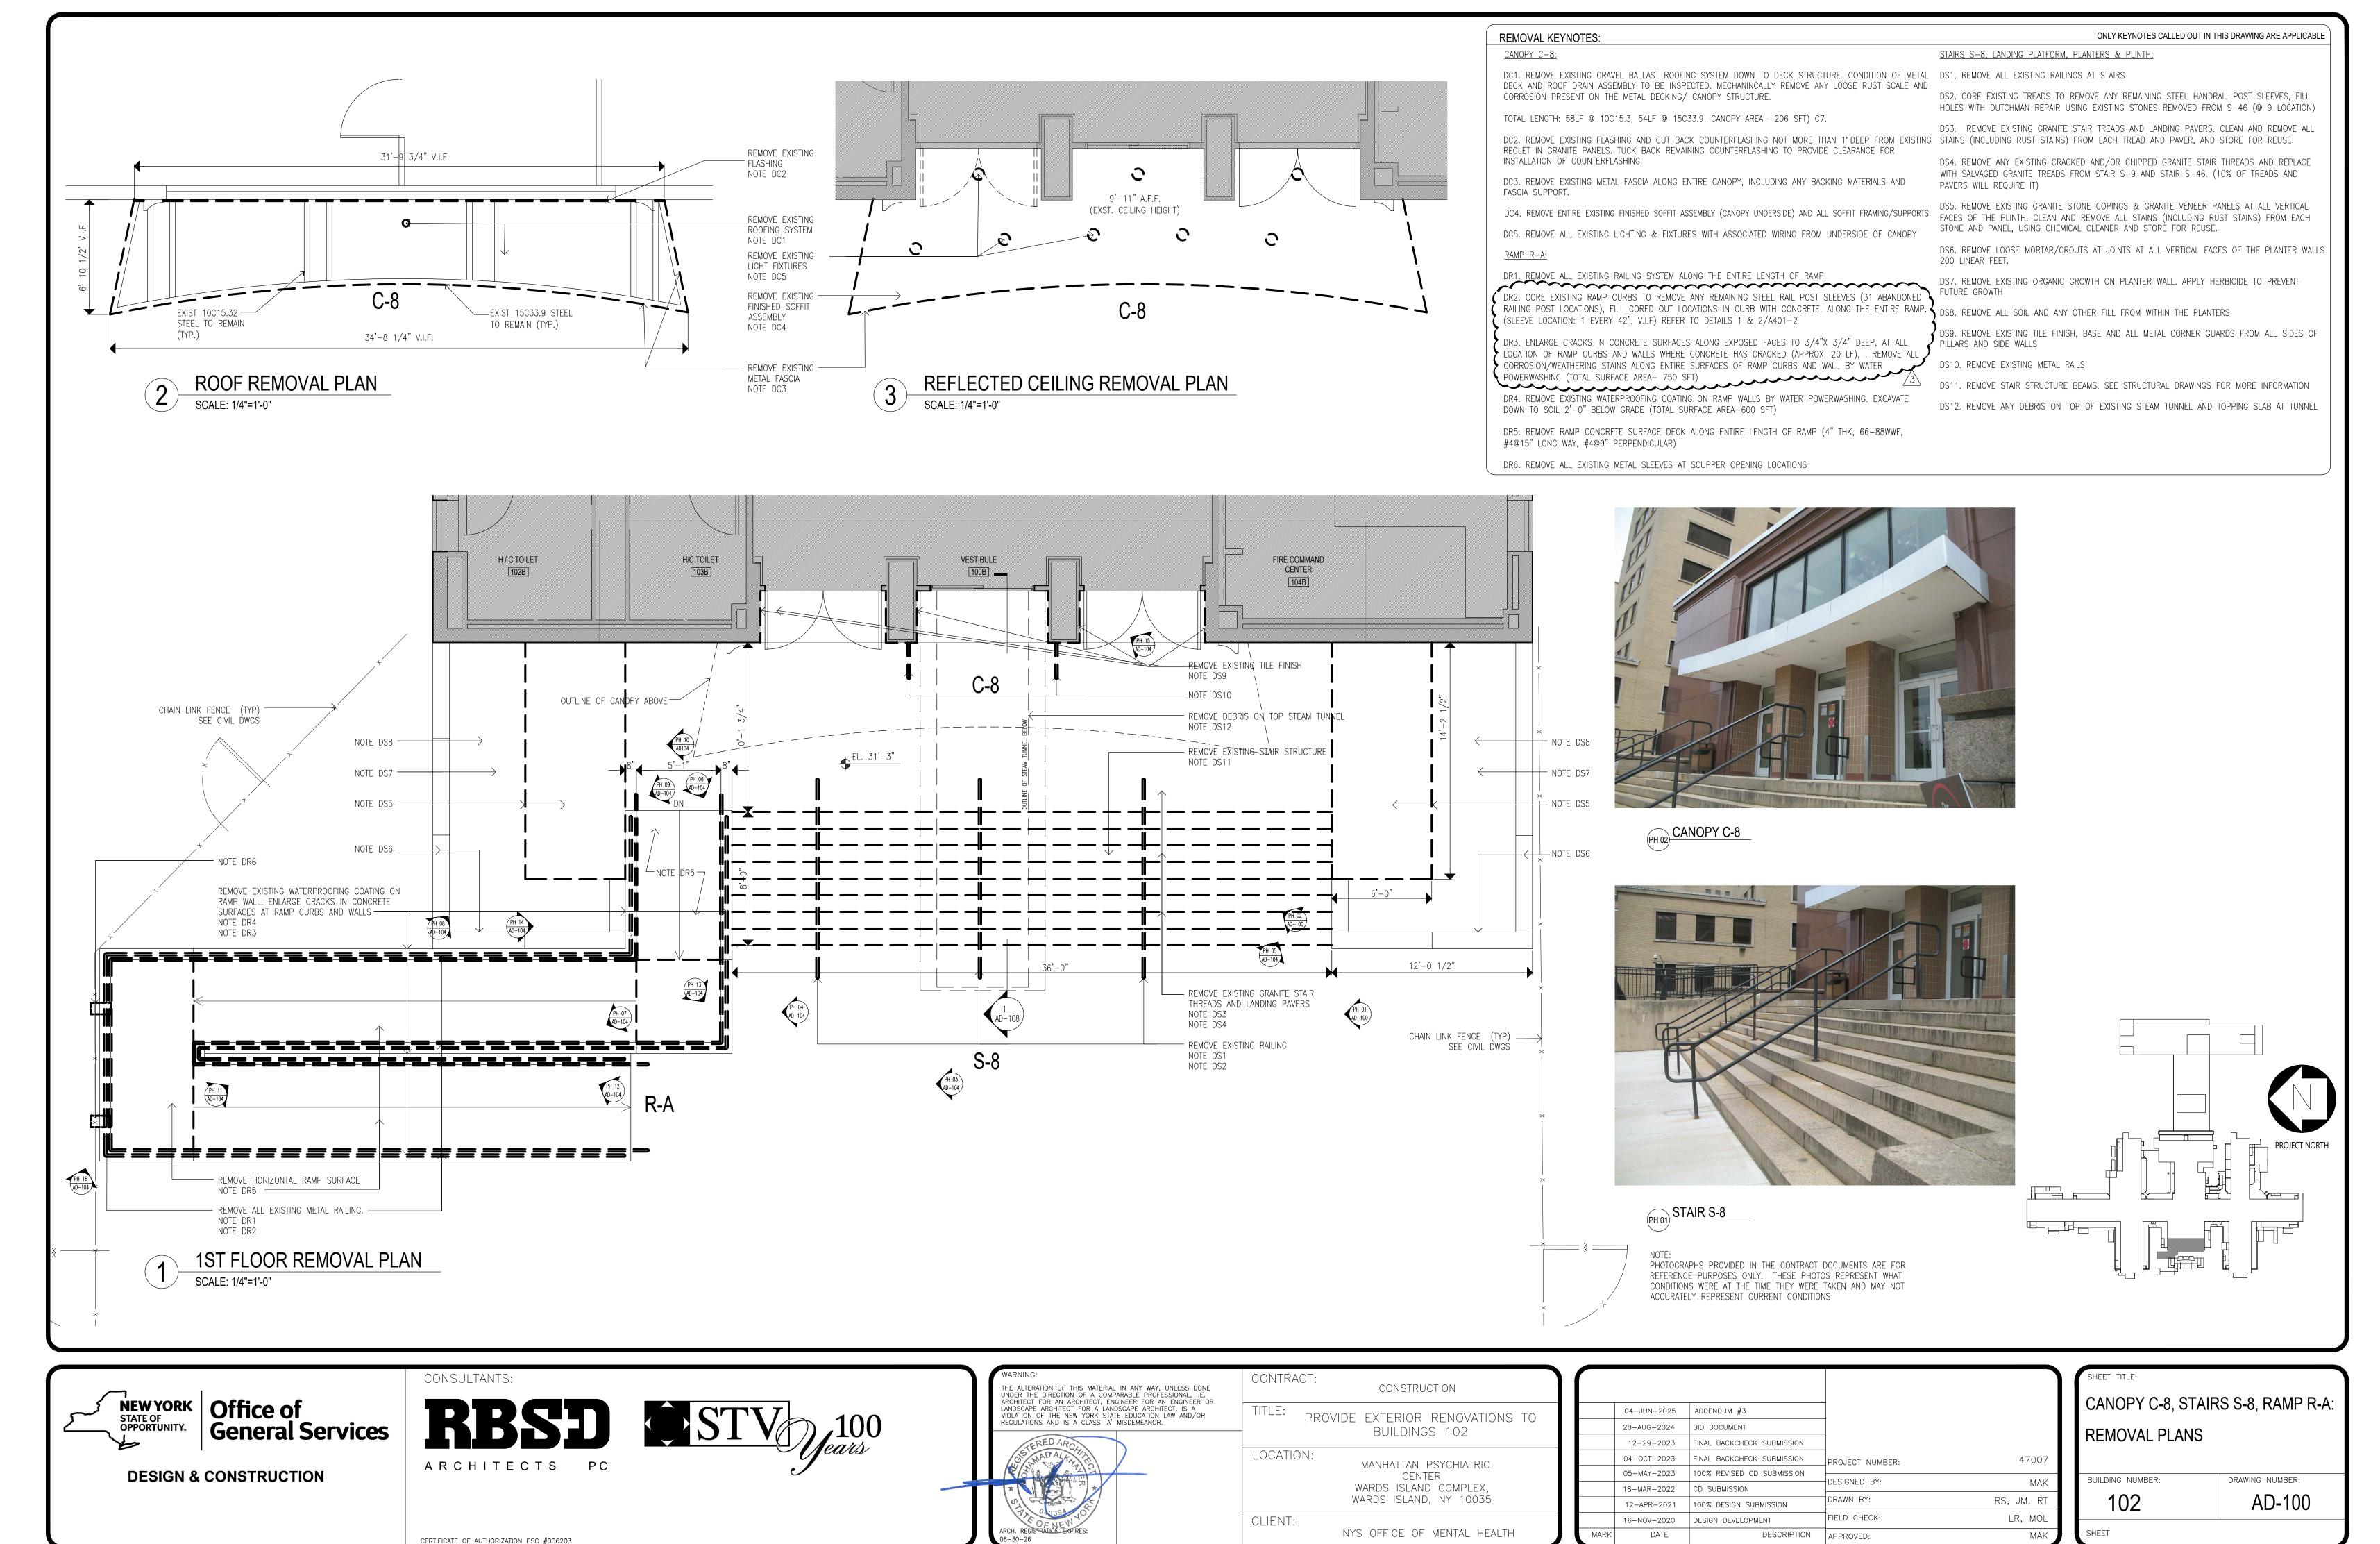

1/6/2025 11:01:57

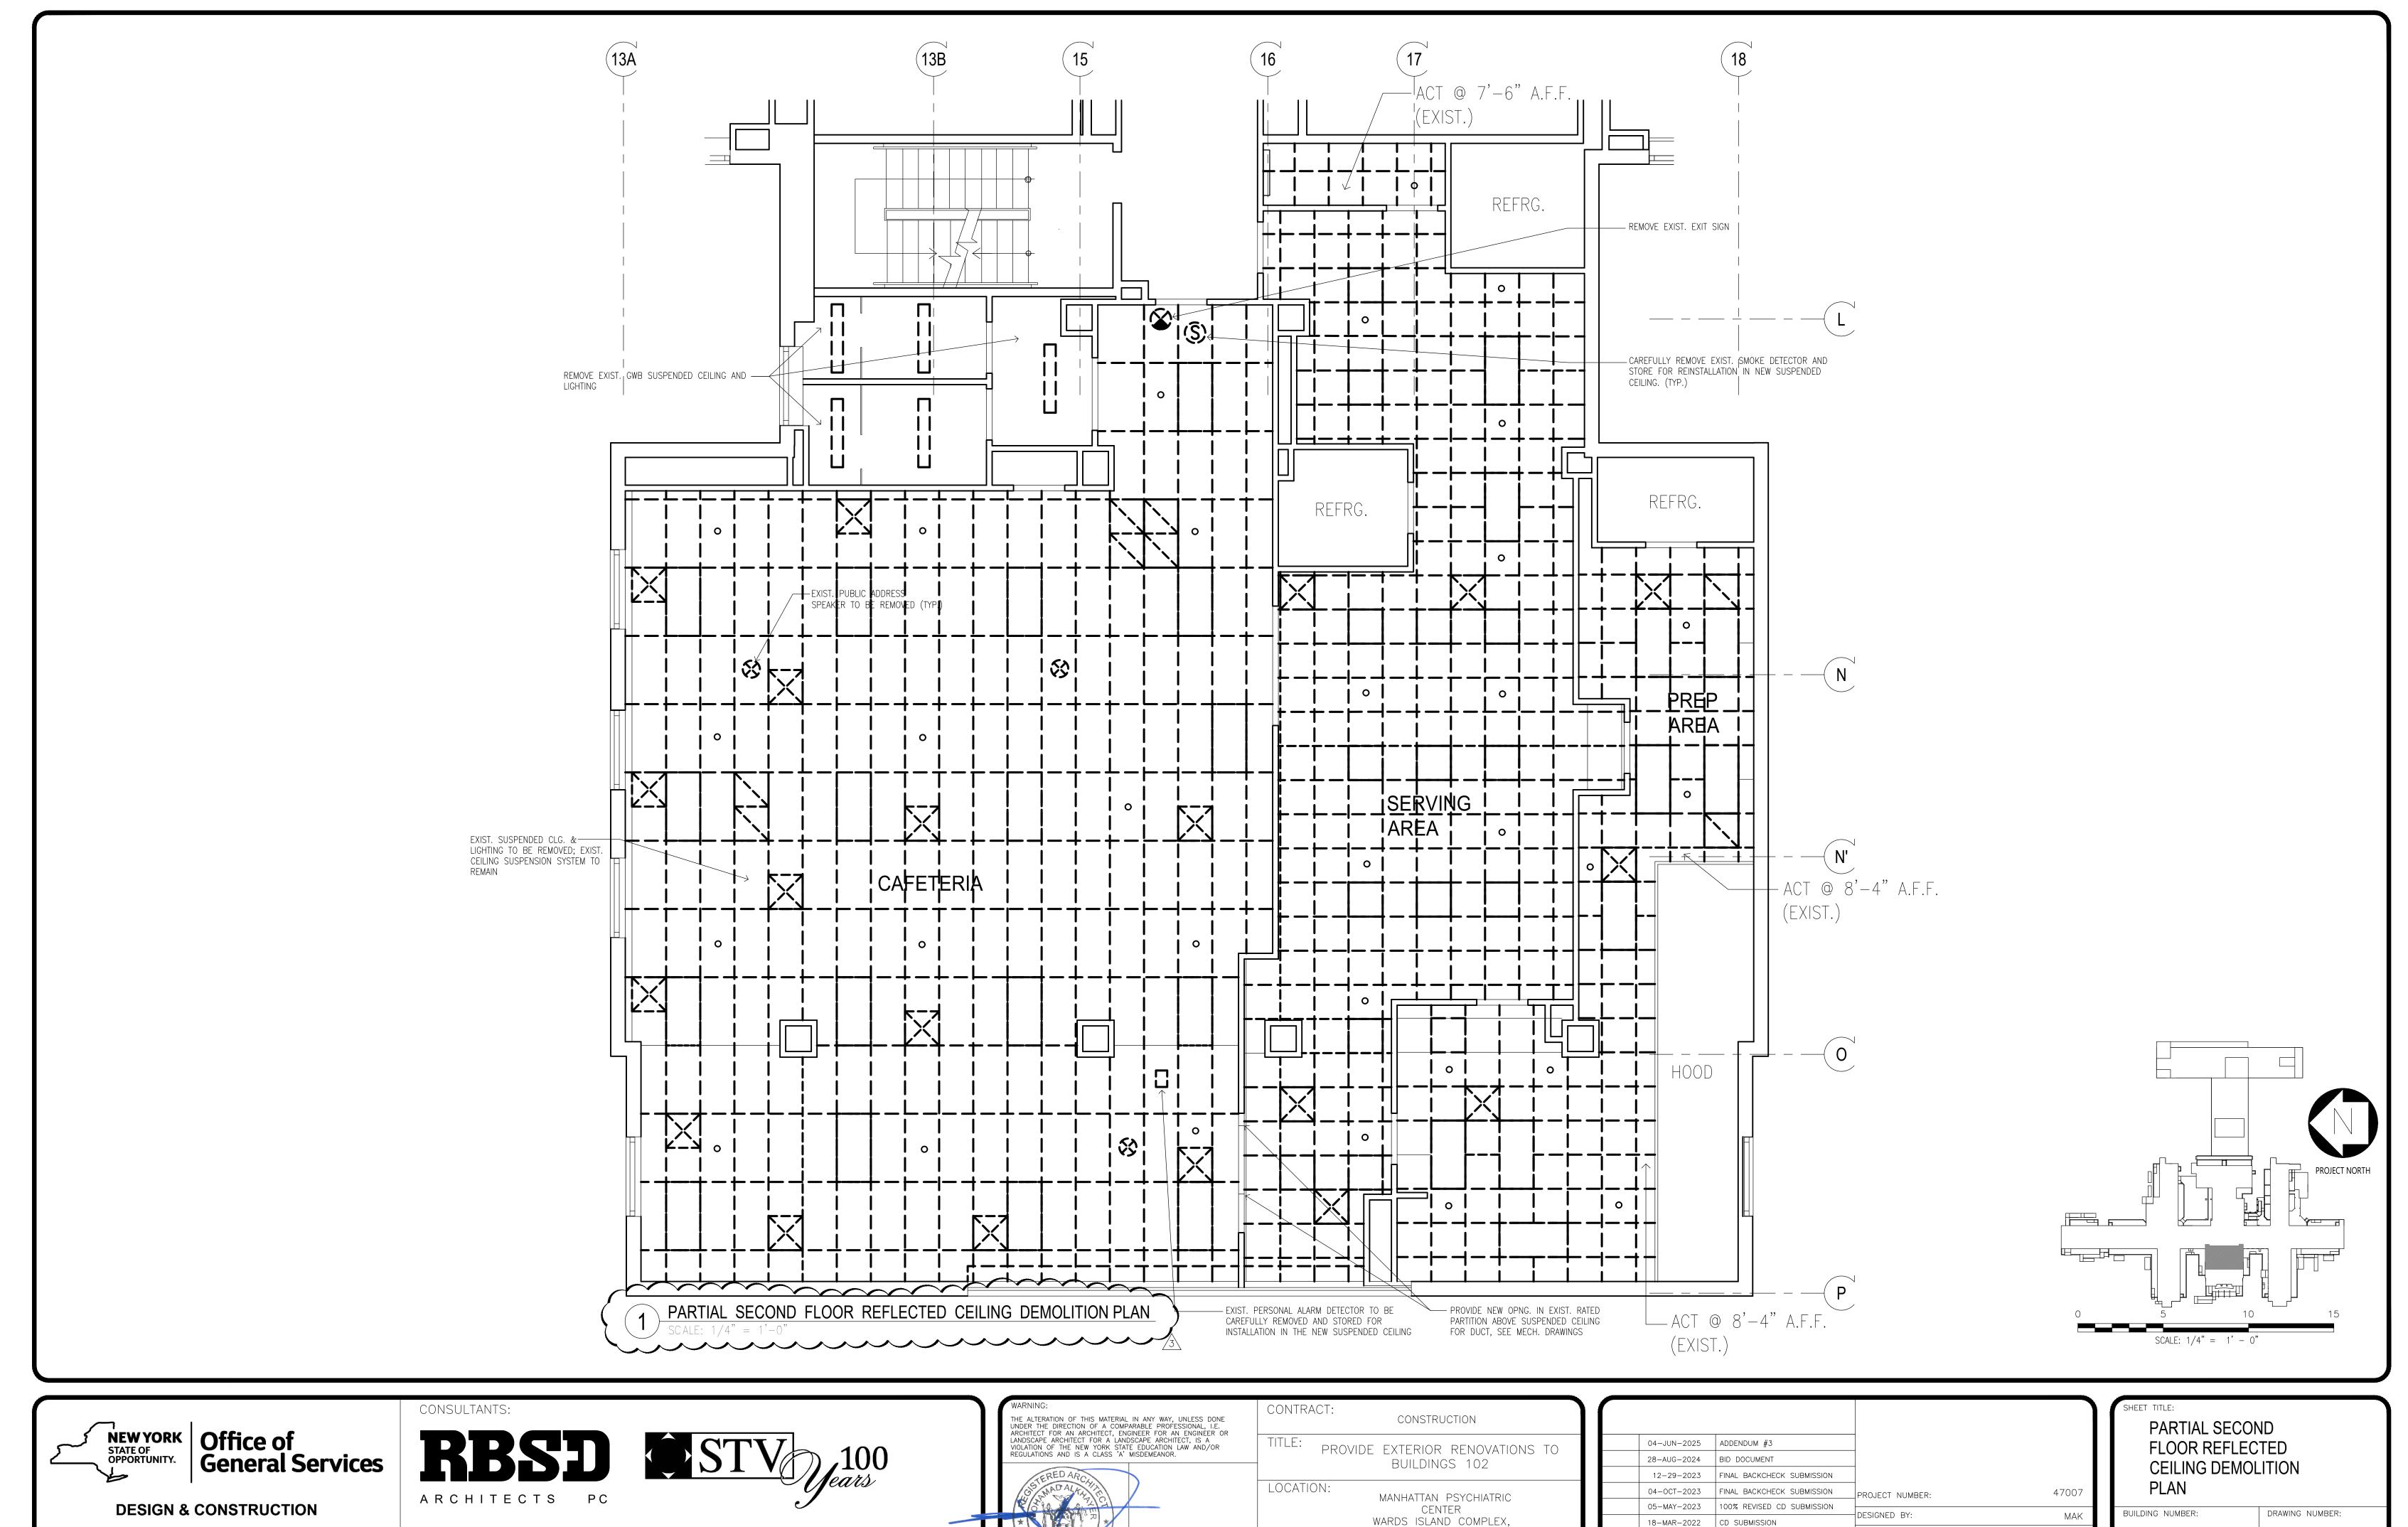

WARDS ISLAND, NY 10035

NYS OFFICE OF MENTAL HEALTH

CLIENT:

AD-107

DRAWN BY:

FIELD CHECK:

DESCRIPTION APPROVED:

12-APR-2021

16-NOV-2020

DATE

100% DESIGN SUBMISSION


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NYS OFFICE OF MENTAL HEALTH

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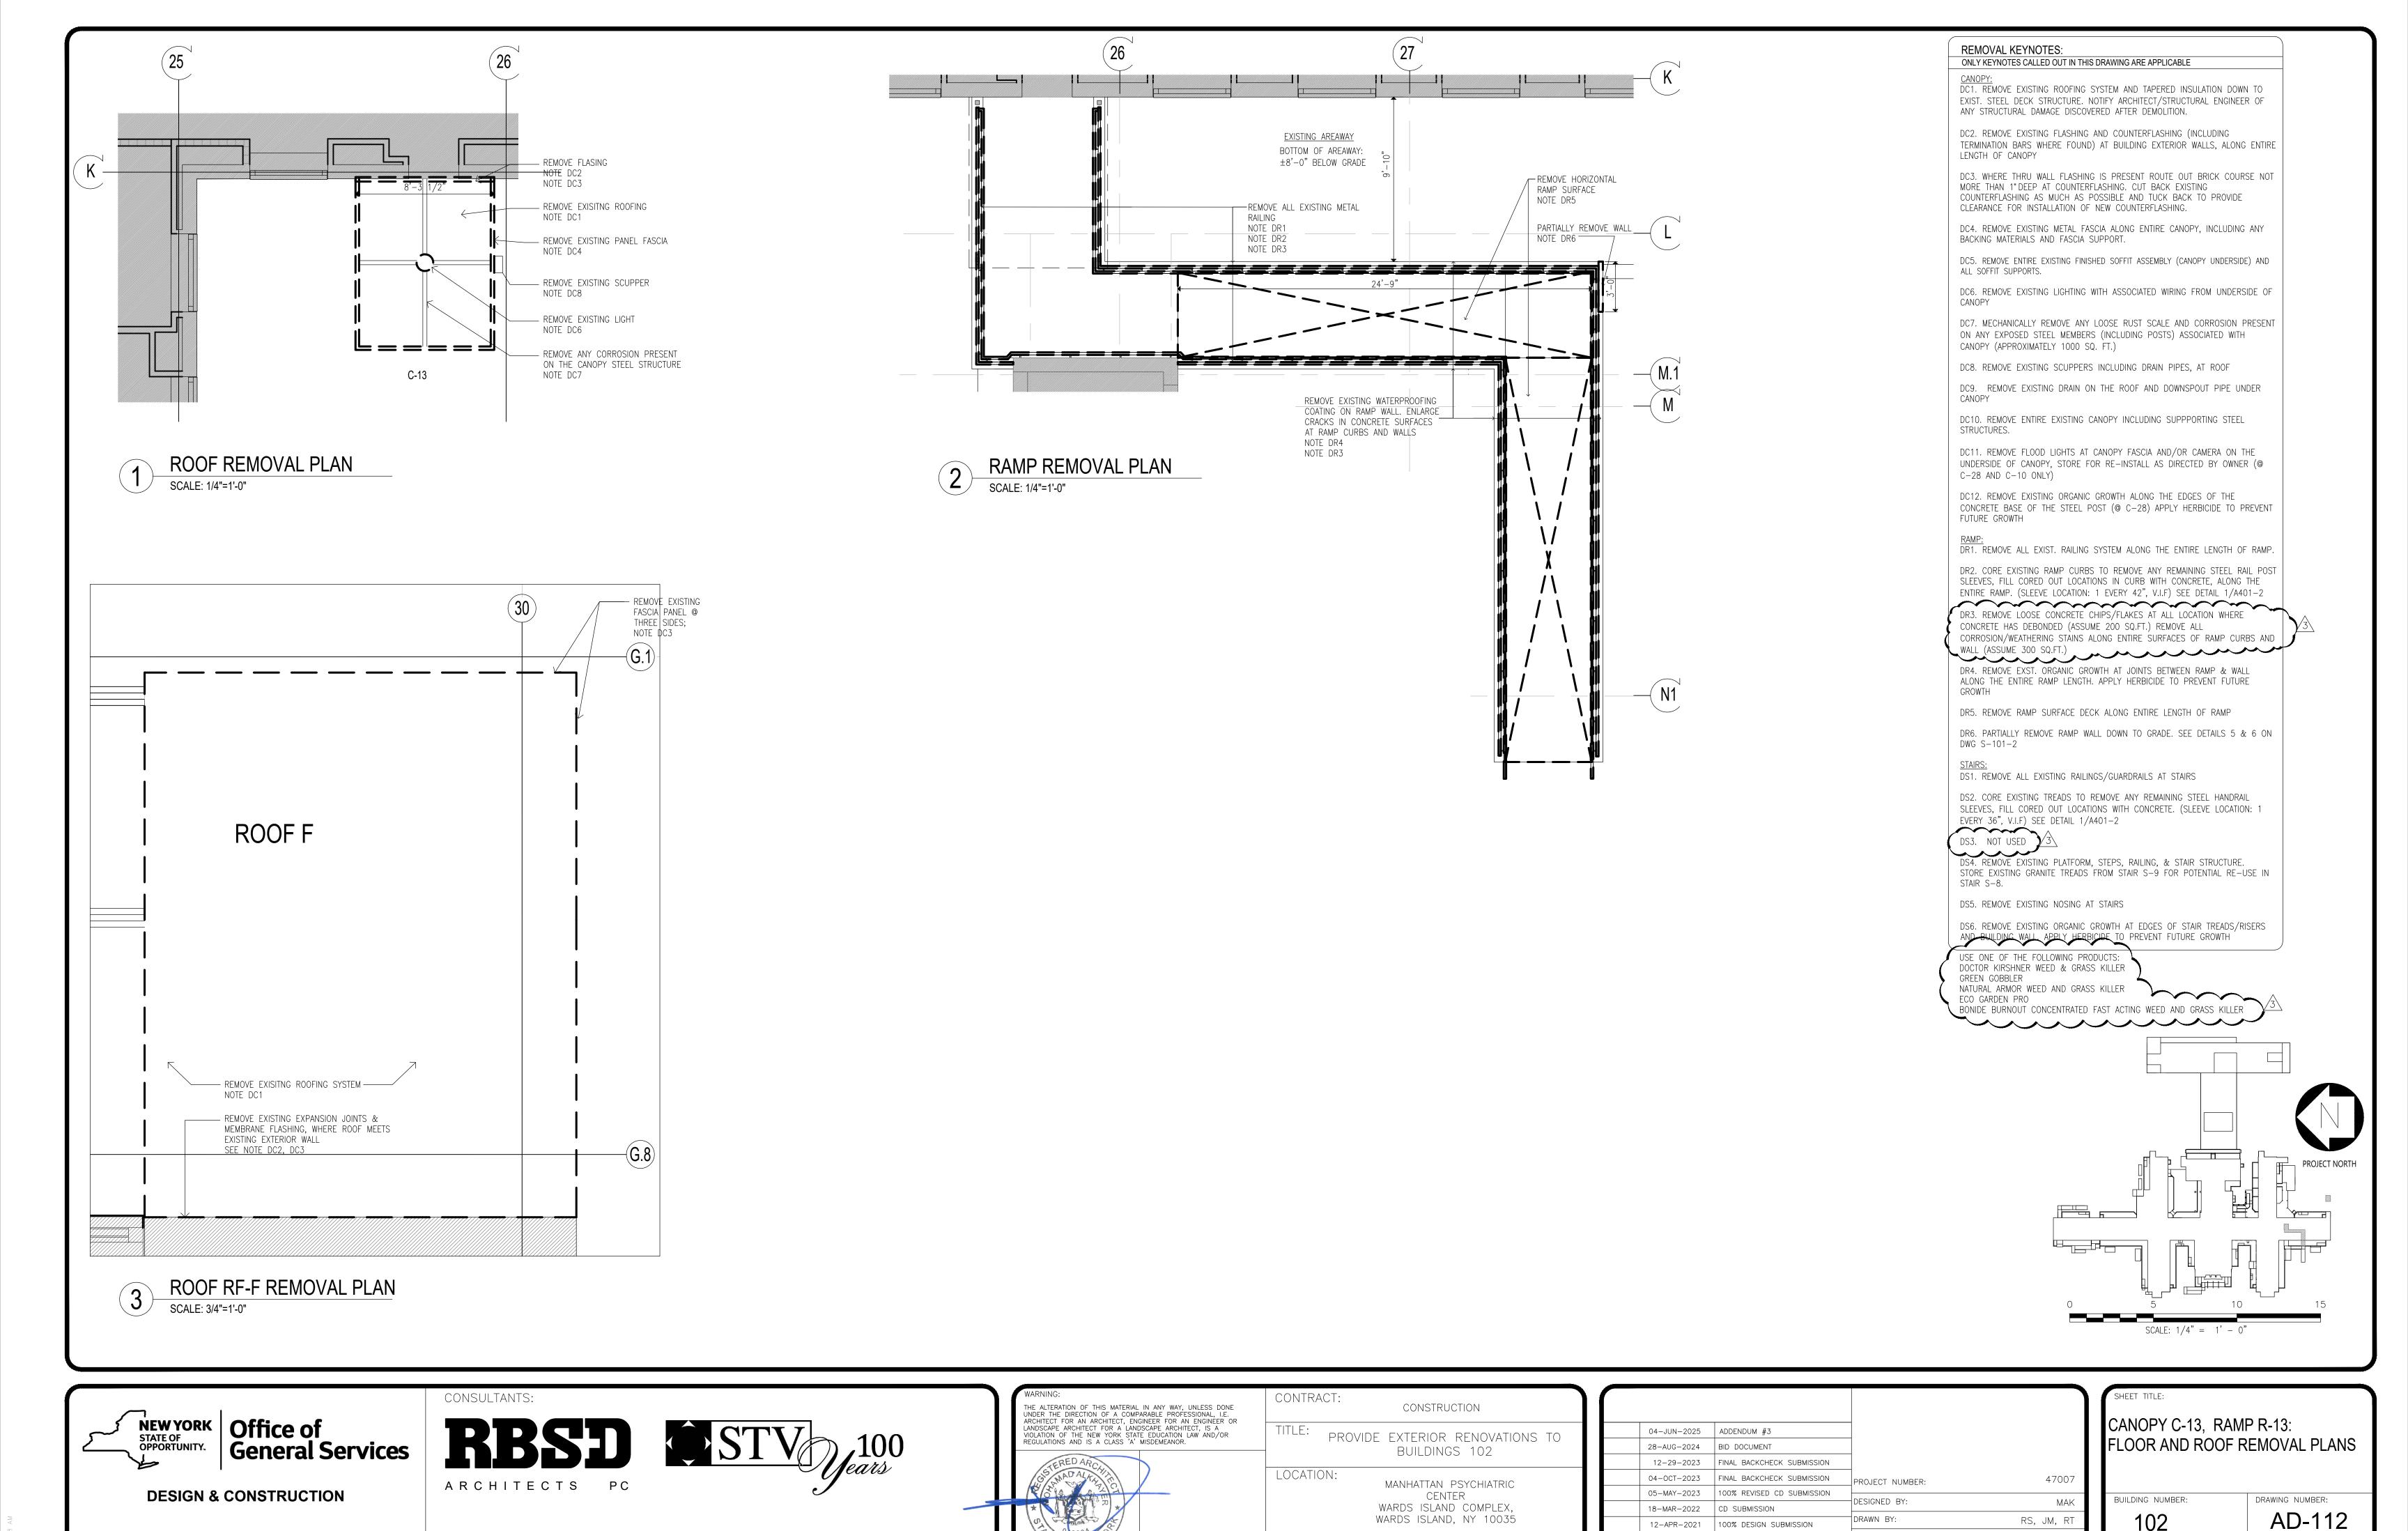
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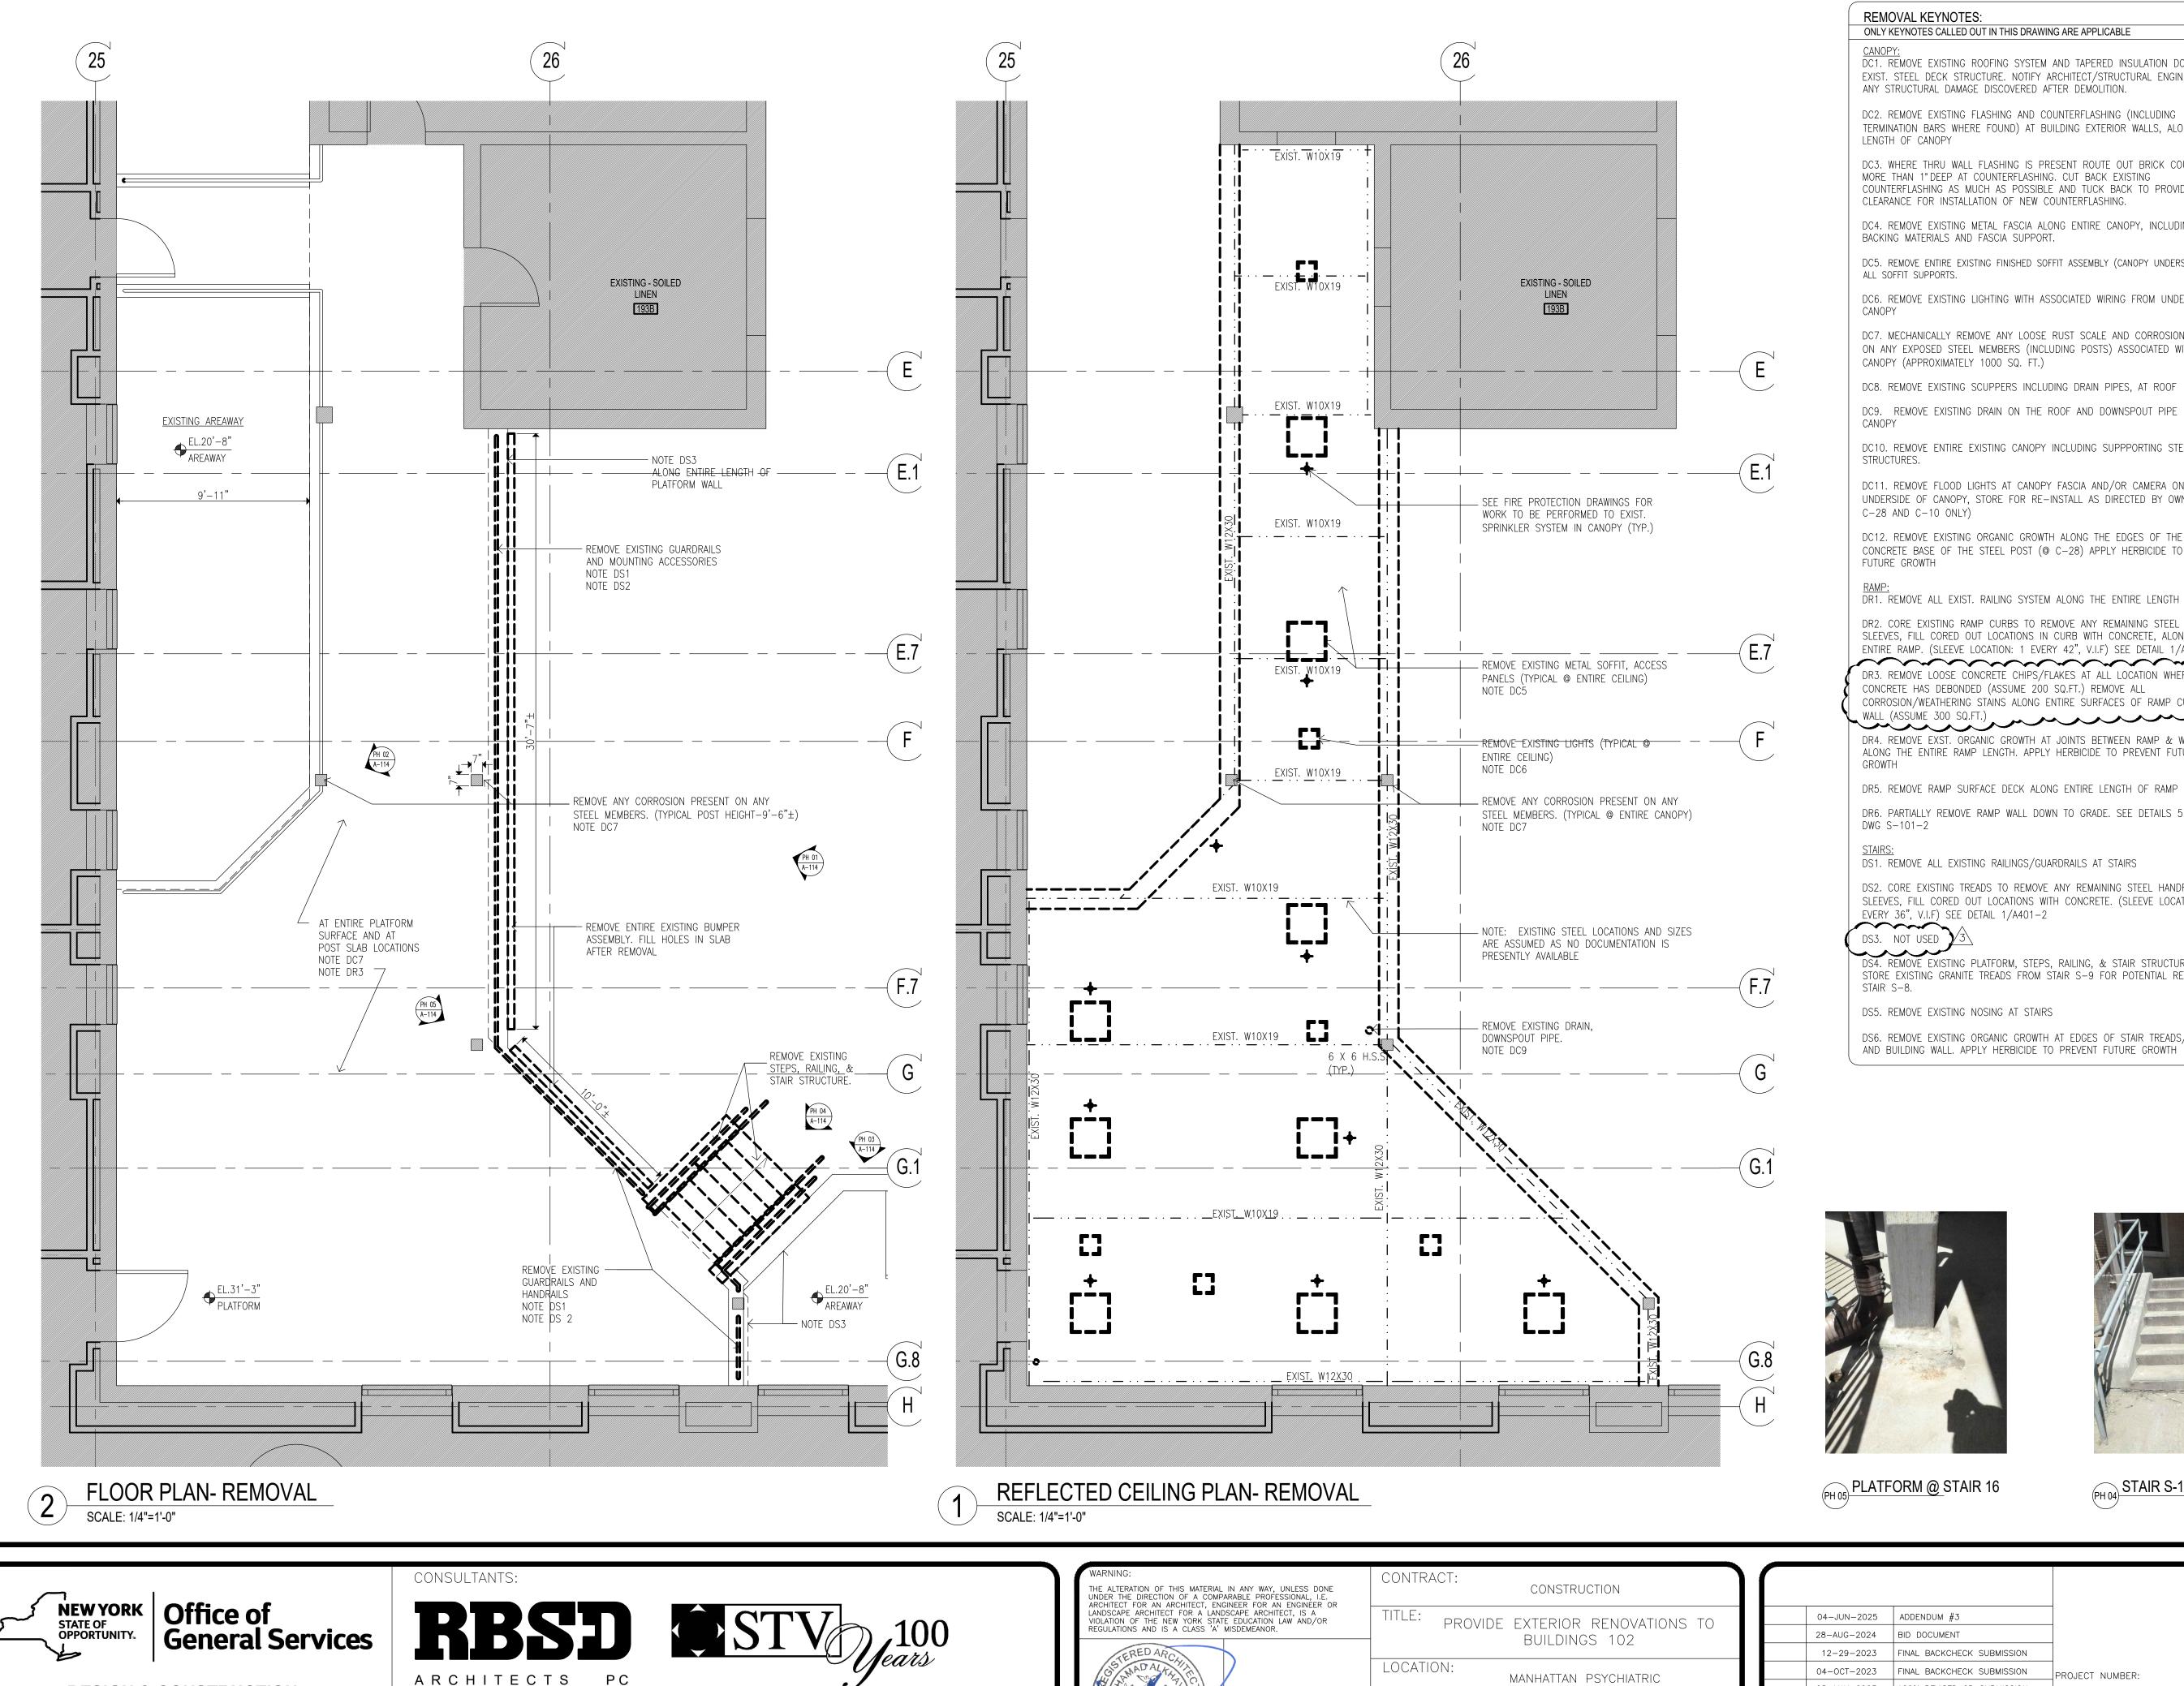
16-NOV-2020

DATE

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LR, MOL

MAK

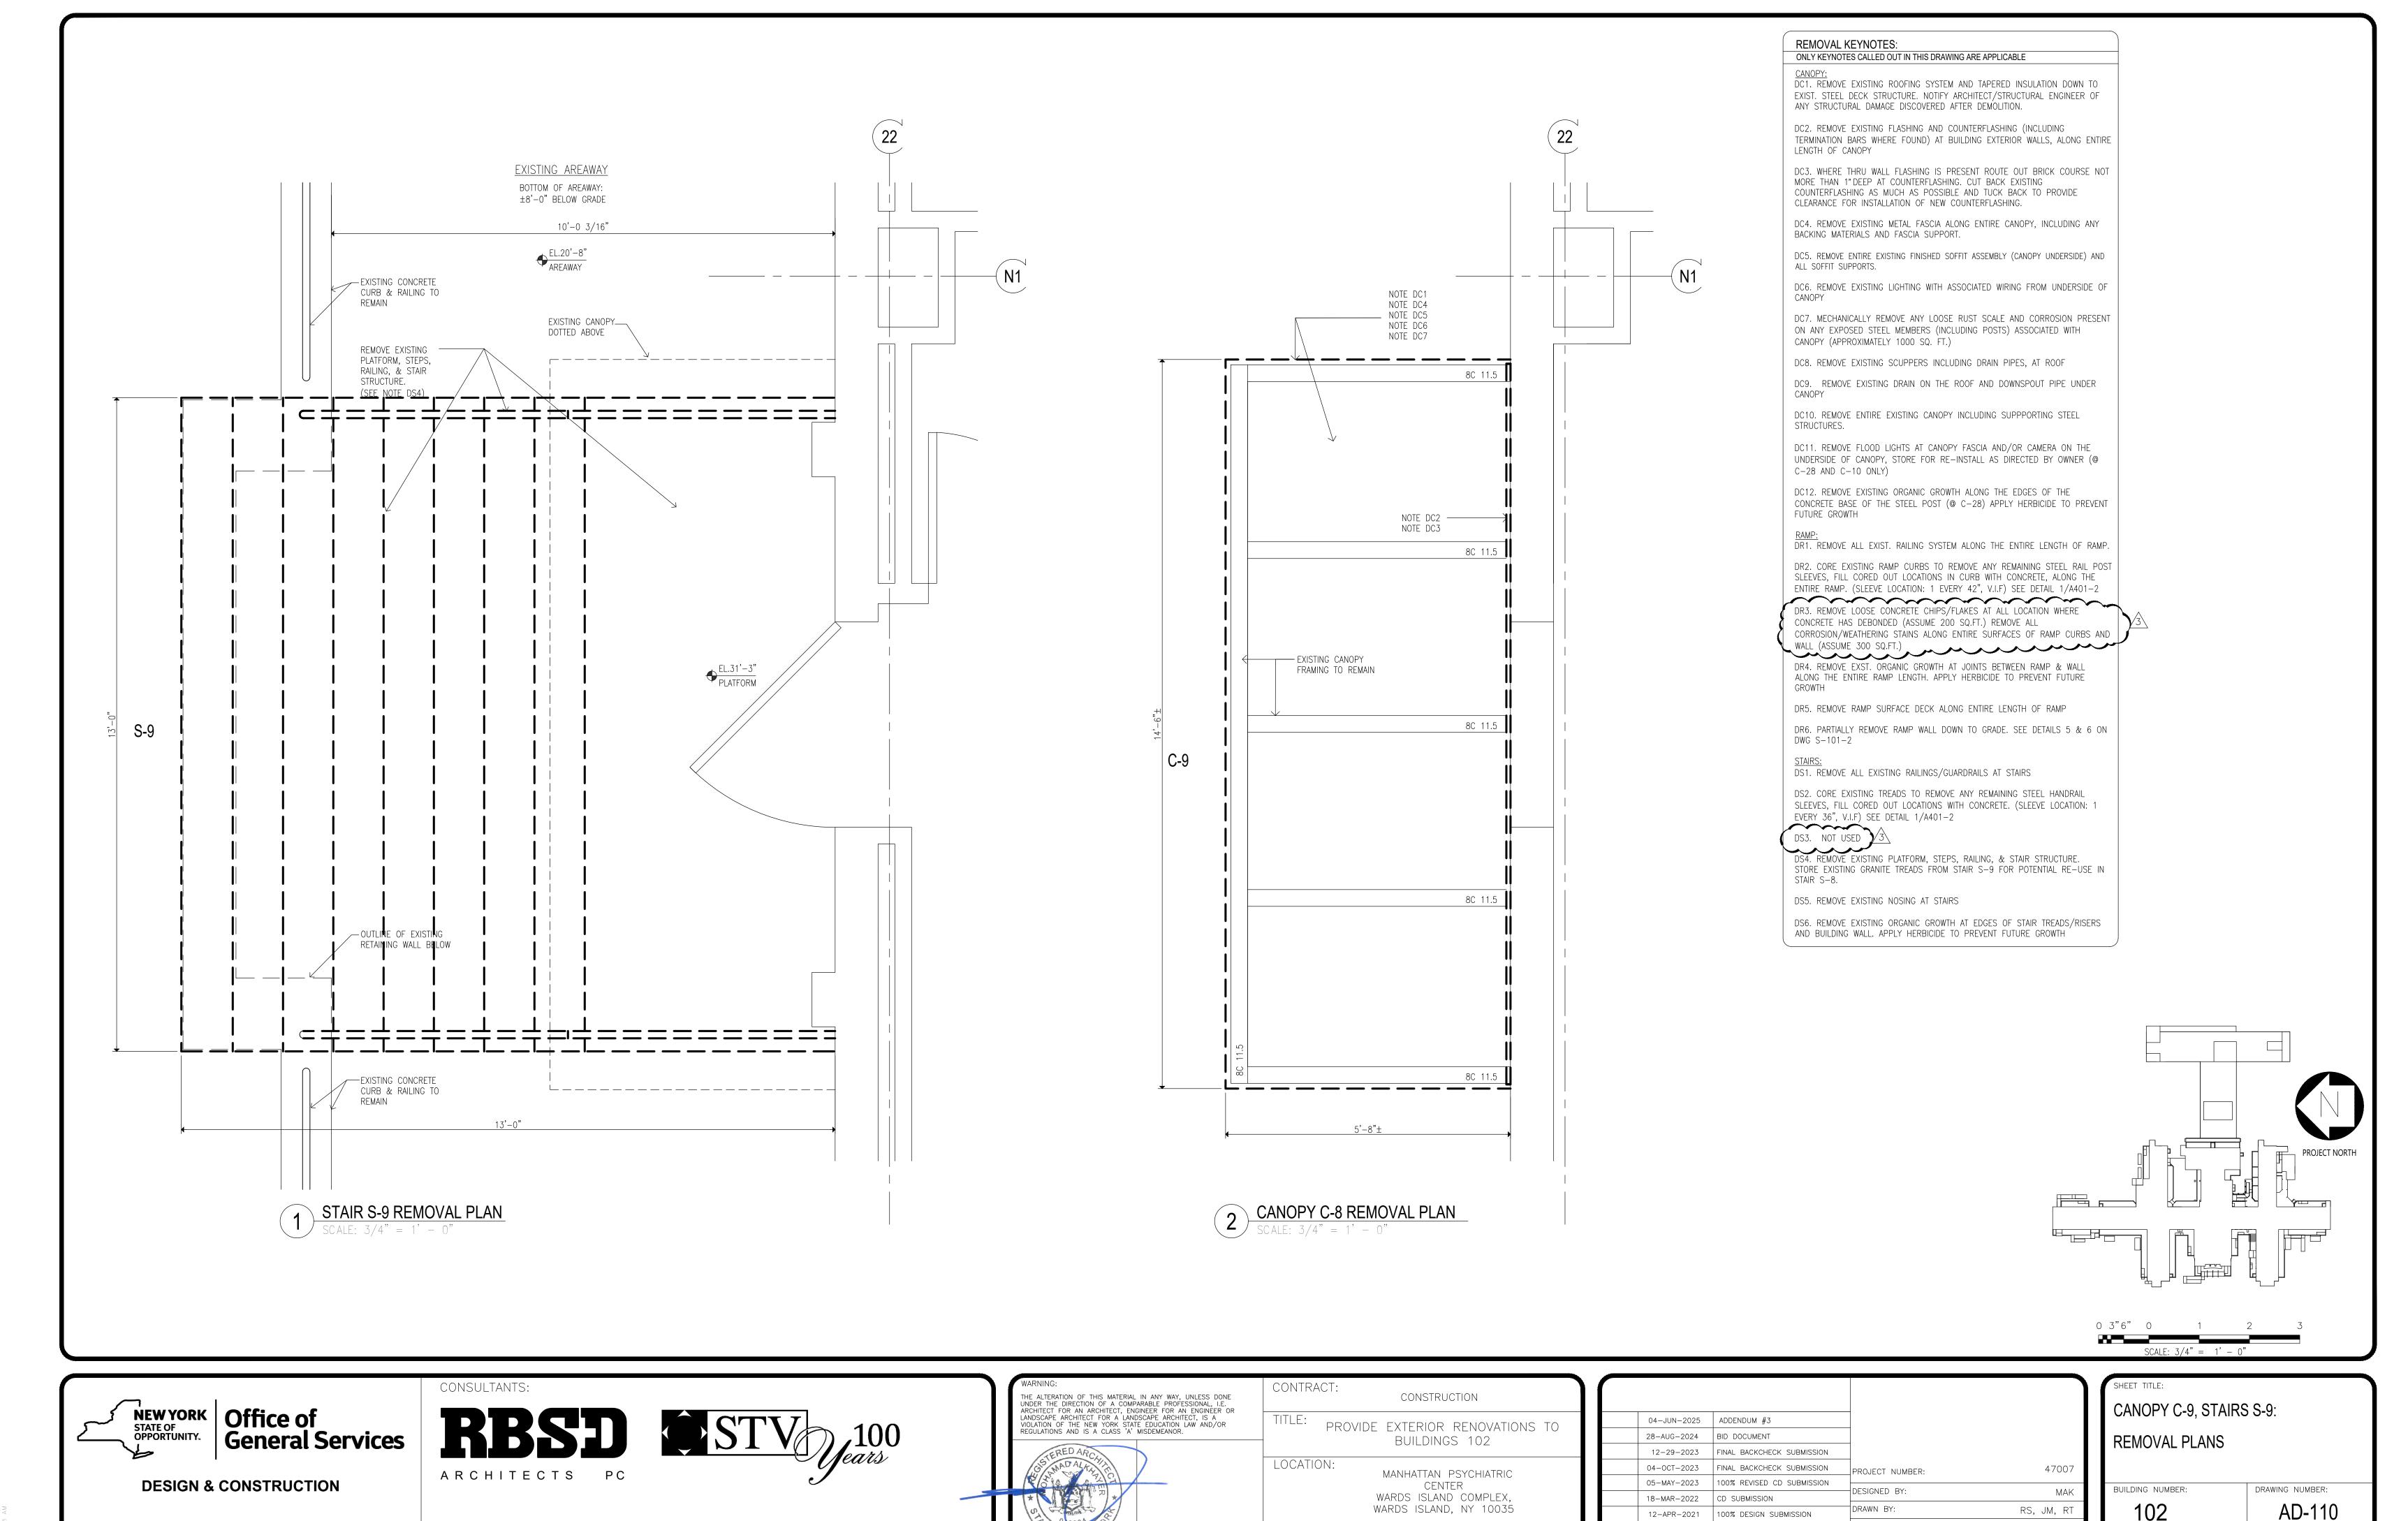

REMOVAL KEYNOTES:

DC1. REMOVE EXISTING ROOFING SYSTEM AND TAPERED INSULATION DOWN TO EXIST. STEEL DECK STRUCTURE. NOTIFY ARCHITECT/STRUCTURAL ENGINEER OF ANY STRUCTURAL DAMAGE DISCOVERED AFTER DEMOLITION.

DC2. REMOVE EXISTING FLASHING AND COUNTERFLASHING (INCLUDING TERMINATION BARS WHERE FOUND) AT BUILDING EXTERIOR WALLS, ALONG ENTIRE

DC3. WHERE THRU WALL FLASHING IS PRESENT ROUTE OUT BRICK COURSE NOT MORE THAN 1" DEEP AT COUNTERFLASHING. CUT BACK EXISTING COUNTERFLASHING AS MUCH AS POSSIBLE AND TUCK BACK TO PROVIDE

DC4. REMOVE EXISTING METAL FASCIA ALONG ENTIRE CANOPY, INCLUDING ANY BACKING MATERIALS AND FASCIA SUPPORT.

DC5. REMOVE ENTIRE EXISTING FINISHED SOFFIT ASSEMBLY (CANOPY UNDERSIDE) AND

DC6. REMOVE EXISTING LIGHTING WITH ASSOCIATED WIRING FROM UNDERSIDE OF

DC7. MECHANICALLY REMOVE ANY LOOSE RUST SCALE AND CORROSION PRESENT ON ANY EXPOSED STEEL MEMBERS (INCLUDING POSTS) ASSOCIATED WITH

DC8. REMOVE EXISTING SCUPPERS INCLUDING DRAIN PIPES, AT ROOF

DC9. REMOVE EXISTING DRAIN ON THE ROOF AND DOWNSPOUT PIPE UNDER

DC10. REMOVE ENTIRE EXISTING CANOPY INCLUDING SUPPPORTING STEEL

DC11. REMOVE FLOOD LIGHTS AT CANOPY FASCIA AND/OR CAMERA ON THE UNDERSIDE OF CANOPY, STORE FOR RE-INSTALL AS DIRECTED BY OWNER (@ C-28 AND C-10 ONLY)

DC12. REMOVE EXISTING ORGANIC GROWTH ALONG THE EDGES OF THE CONCRETE BASE OF THE STEEL POST (@ C-28) APPLY HERBICIDE TO PREVENT FUTURE GROWTH

DR1. REMOVE ALL EXIST. RAILING SYSTEM ALONG THE ENTIRE LENGTH OF RAMP.

DR2. CORE EXISTING RAMP CURBS TO REMOVE ANY REMAINING STEEL RAIL POST SLEEVES, FILL CORED OUT LOCATIONS IN CURB WITH CONCRETE, ALONG THE ENTIRE RAMP. (SLEEVE LOCATION: 1 EVERY 42", V.I.F) SEE DETAIL 1/A401-2 ENTITE IVANIA (SEELVE ESSAIIS). DR3. REMOVE LOOSE CONCRETE CHIPS/FLAKES AT ALL LOCATION WHERE

CONCRETE HAS DEBONDED (ASSUME 200 SQ.FT.) REMOVE ALL CORROSION/WEATHERING STAINS ALONG ENTIRE SURFACES OF RAMP CURBS AND 

DR4. REMOVE EXST. ORGANIC GROWTH AT JOINTS BETWEEN RAMP & WALL ALONG THE ENTIRE RAMP LENGTH. APPLY HERBICIDE TO PREVENT FUTURE

DR6. PARTIALLY REMOVE RAMP WALL DOWN TO GRADE. SEE DETAILS 5 & 6 ON DWG S-101-2

DS1. REMOVE ALL EXISTING RAILINGS/GUARDRAILS AT STAIRS

DS2. CORE EXISTING TREADS TO REMOVE ANY REMAINING STEEL HANDRAIL SLEEVES, FILL CORED OUT LOCATIONS WITH CONCRETE. (SLEEVE LOCATION: 1 EVERY 36", V.I.F) SEE DETAIL 1/A401-2

DS4. REMOVE EXISTING PLATFORM, STEPS, RAILING, & STAIR STRUCTURE. STORE EXISTING GRANITE TREADS FROM STAIR S-9 FOR POTENTIAL RE-USE IN

DS5. REMOVE EXISTING NOSING AT STAIRS

DS6. REMOVE EXISTING ORGANIC GROWTH AT EDGES OF STAIR TREADS/RISERS AND BUILDING WALL. APPLY HERBICIDE TO PREVENT FUTURE GROWTH



PLATFORM @ STAIR S-16






PH 03 STAIR S-16

NOTE:
PHOTOGRAPHS PROVIDED IN THE CONTRACT DOCUMENTS ARE FOR REFERENCE PURPOSES ONLY. THESE PHOTOS REPRESENT WHAT CONDITIONS WERE AT THE TIME THEY WERE TAKEN AND MAY NOT ACCURATELY REPRESENT CURRENT CONDITIONS







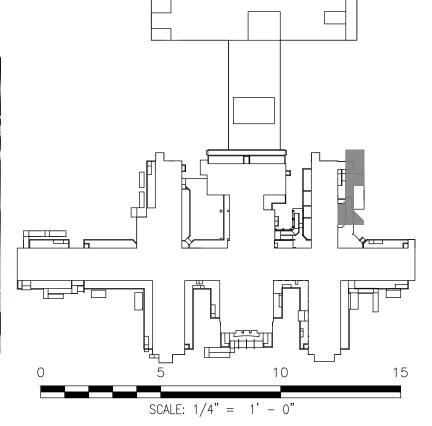

**DESIGN & CONSTRUCTION** 

CERTIFICATE OF AUTHORIZATION PSC #006203



7	WARNING:	CONTRACT
	THE ALTERATION OF THIS MATERIAL IN ANY WAY, UNLESS DONE UNDER THE DIRECTION OF A COMPARABLE PROFESSIONAL, I.E. ARCHITECT FOR AN ARCHITECT, ENGINEER FOR AN ENGINEER OR LANDSCAPE ARCHITECT, IS A VIOLATION OF THE NEW YORK STATE EDUCATION LAW AND/OR REGULATIONS AND IS A CLASS 'A' MISDEMEANOR.	TITLE: P
	STERED ARCHITCH  STERED	LOCATION
	ARCH. REGISTRATION EXPIRES:  06-30-26	CLIENT:


DONE , I.E. EER OR	CONTRACT: CONSTRUCTION
A A D/OR	TITLE: PROVIDE EXTERIOR RENOVATIONS TO BUILDINGS 102
	LOCATION:  MANHATTAN PSYCHIATRIC  CENTER  WARDS ISLAND COMPLEX,  WARDS ISLAND, NY 10035
	CLIENT:  NYS OFFICE OF MENTAL HEALTH

	24 1111 222			
	04-JUN-2025 28-AUG-2024	ADDENDUM #3 BID DOCUMENT		
	12-29-2023	FINAL BACKCHECK SUBMISSION		
	04-OCT-2023	FINAL BACKCHECK SUBMISSION	]  PROJECT_NUMBER:	47007
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	18-MAR-2022	CD SUBMISSION	DESIGNED BY:	MAK
	12-APR-2021	100% DESIGN SUBMISSION	DRAWN BY:	RS, JM, RT
	16-NOV-2020	DESIGN DEVELOPMENT	FIELD CHECK:	LR, MOL
MARK	DATE	DESCRIPTION	APPROVED:	MAK

CANOPY C-16, STAIRS S-16: REMOVAL PLANS

SHEET

BUILDING NUMBER AD-114

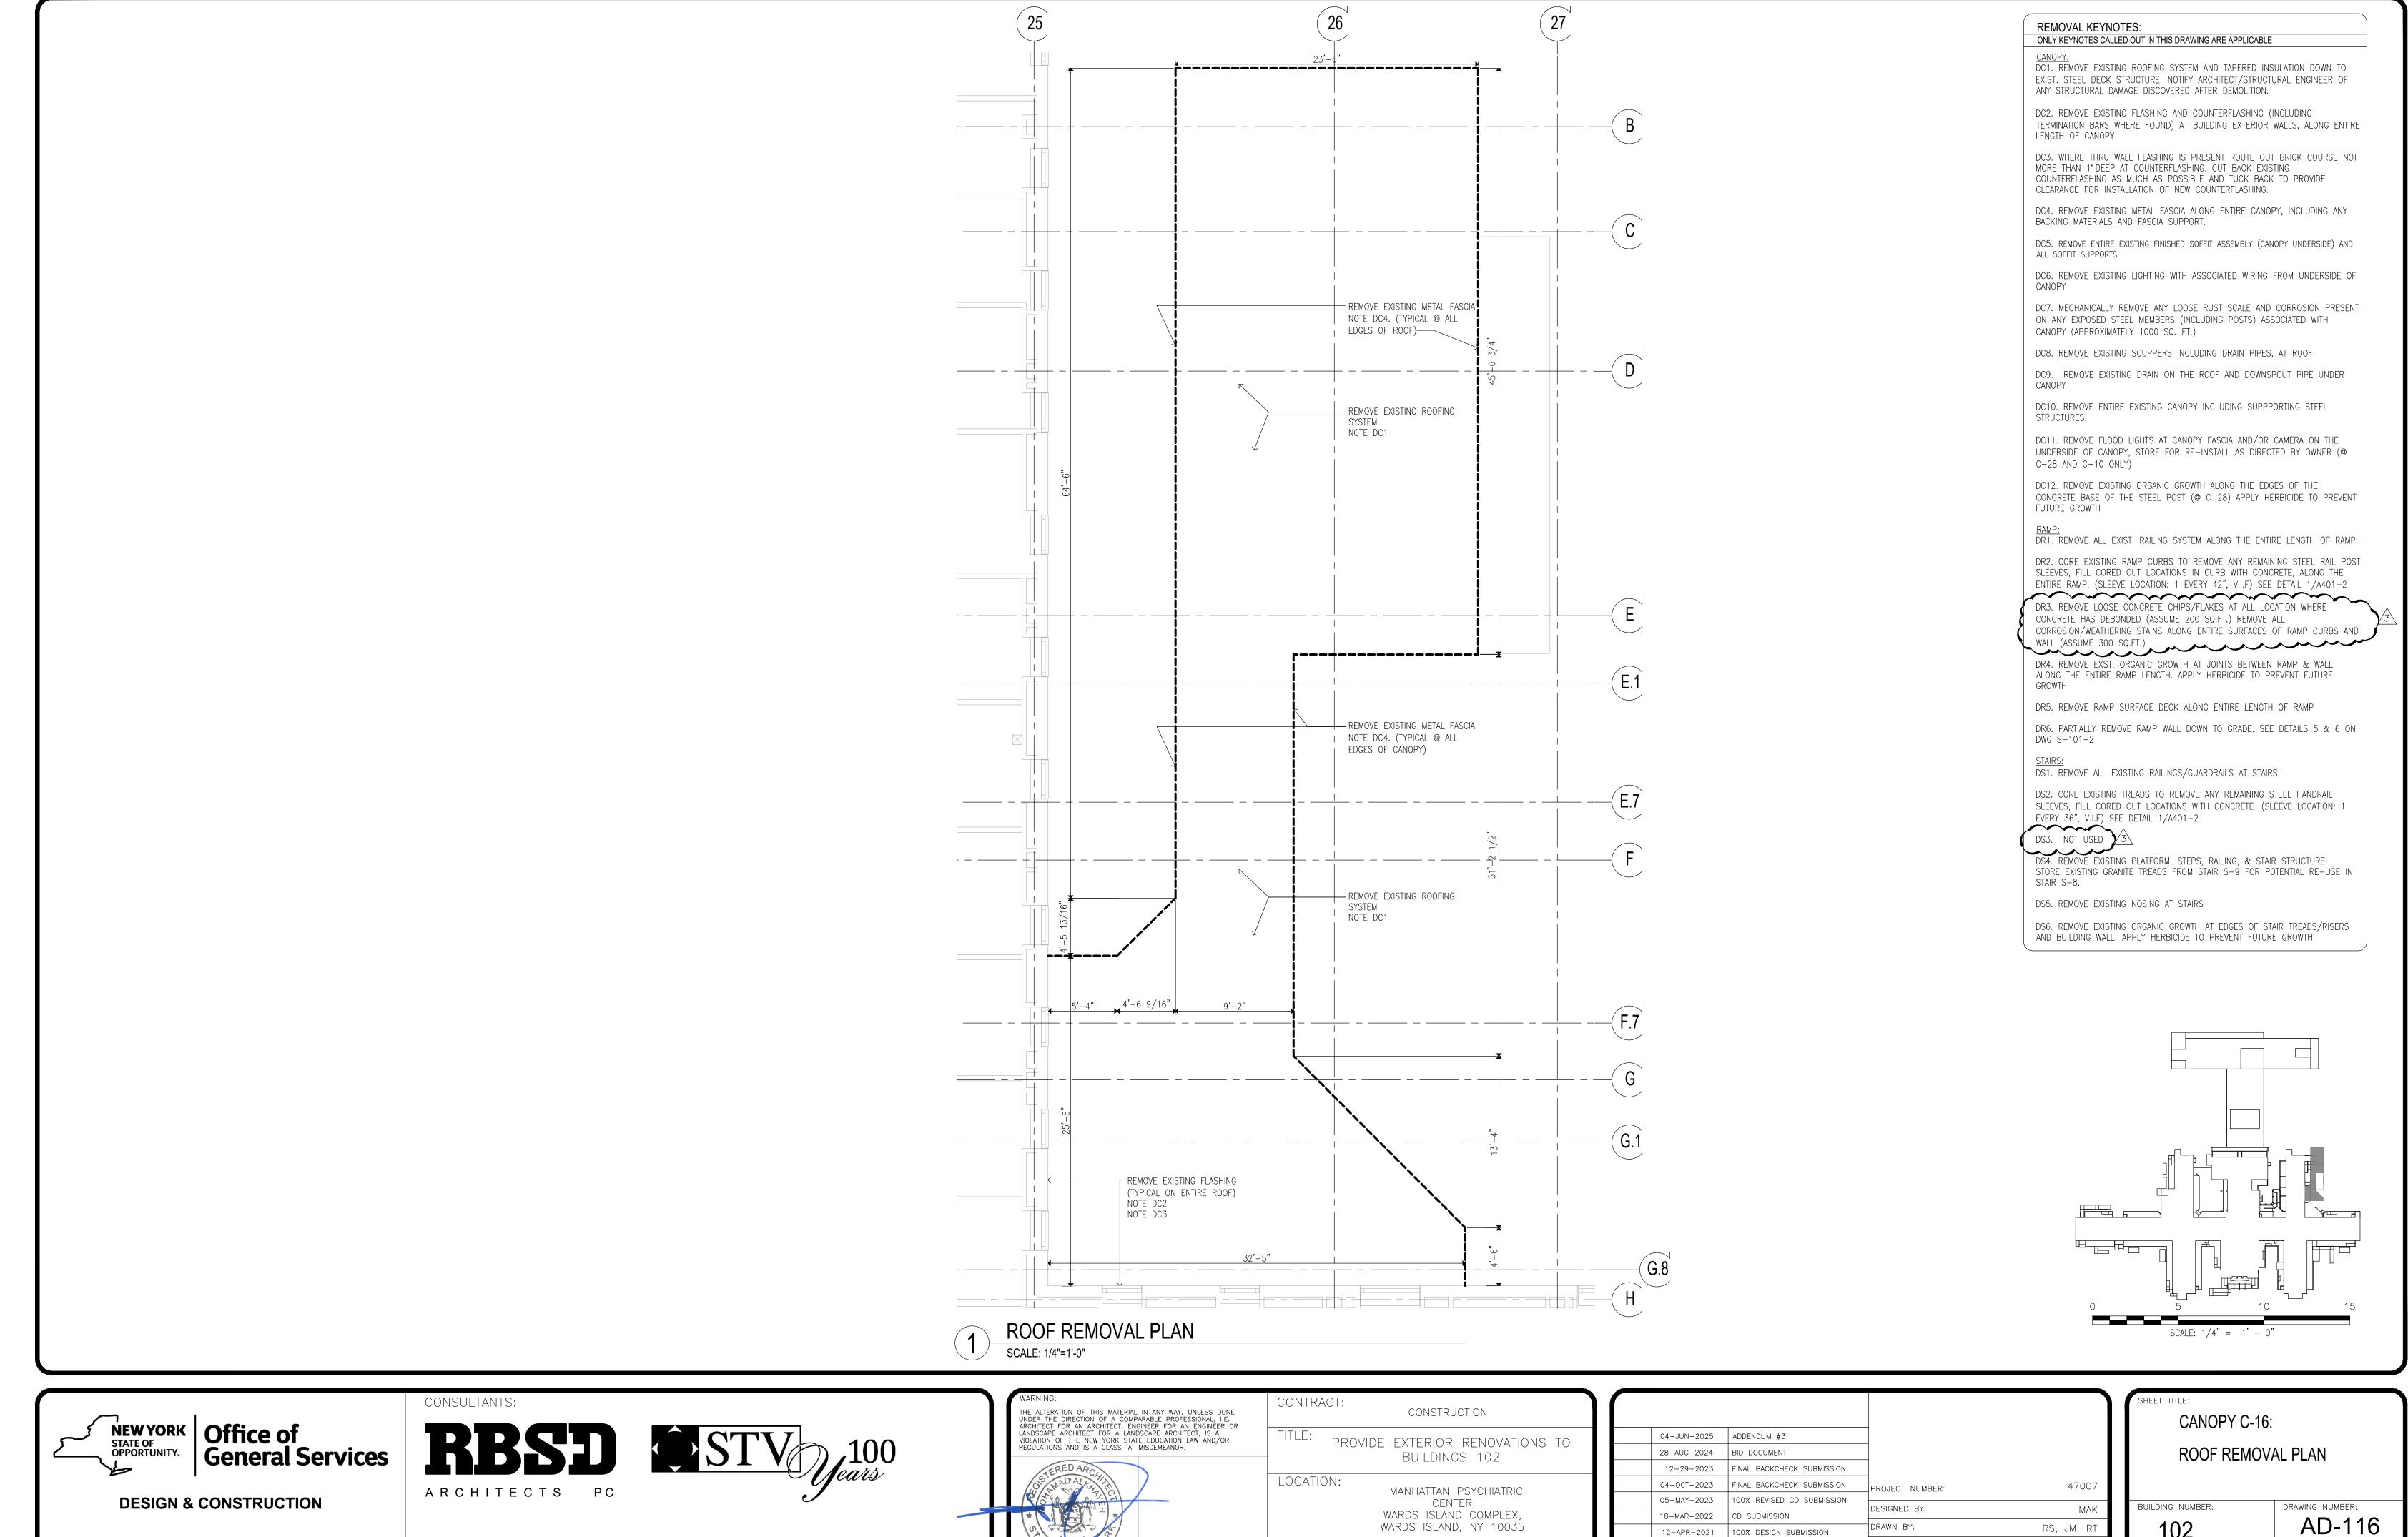

NYS OFFICE OF MENTAL HEALTH

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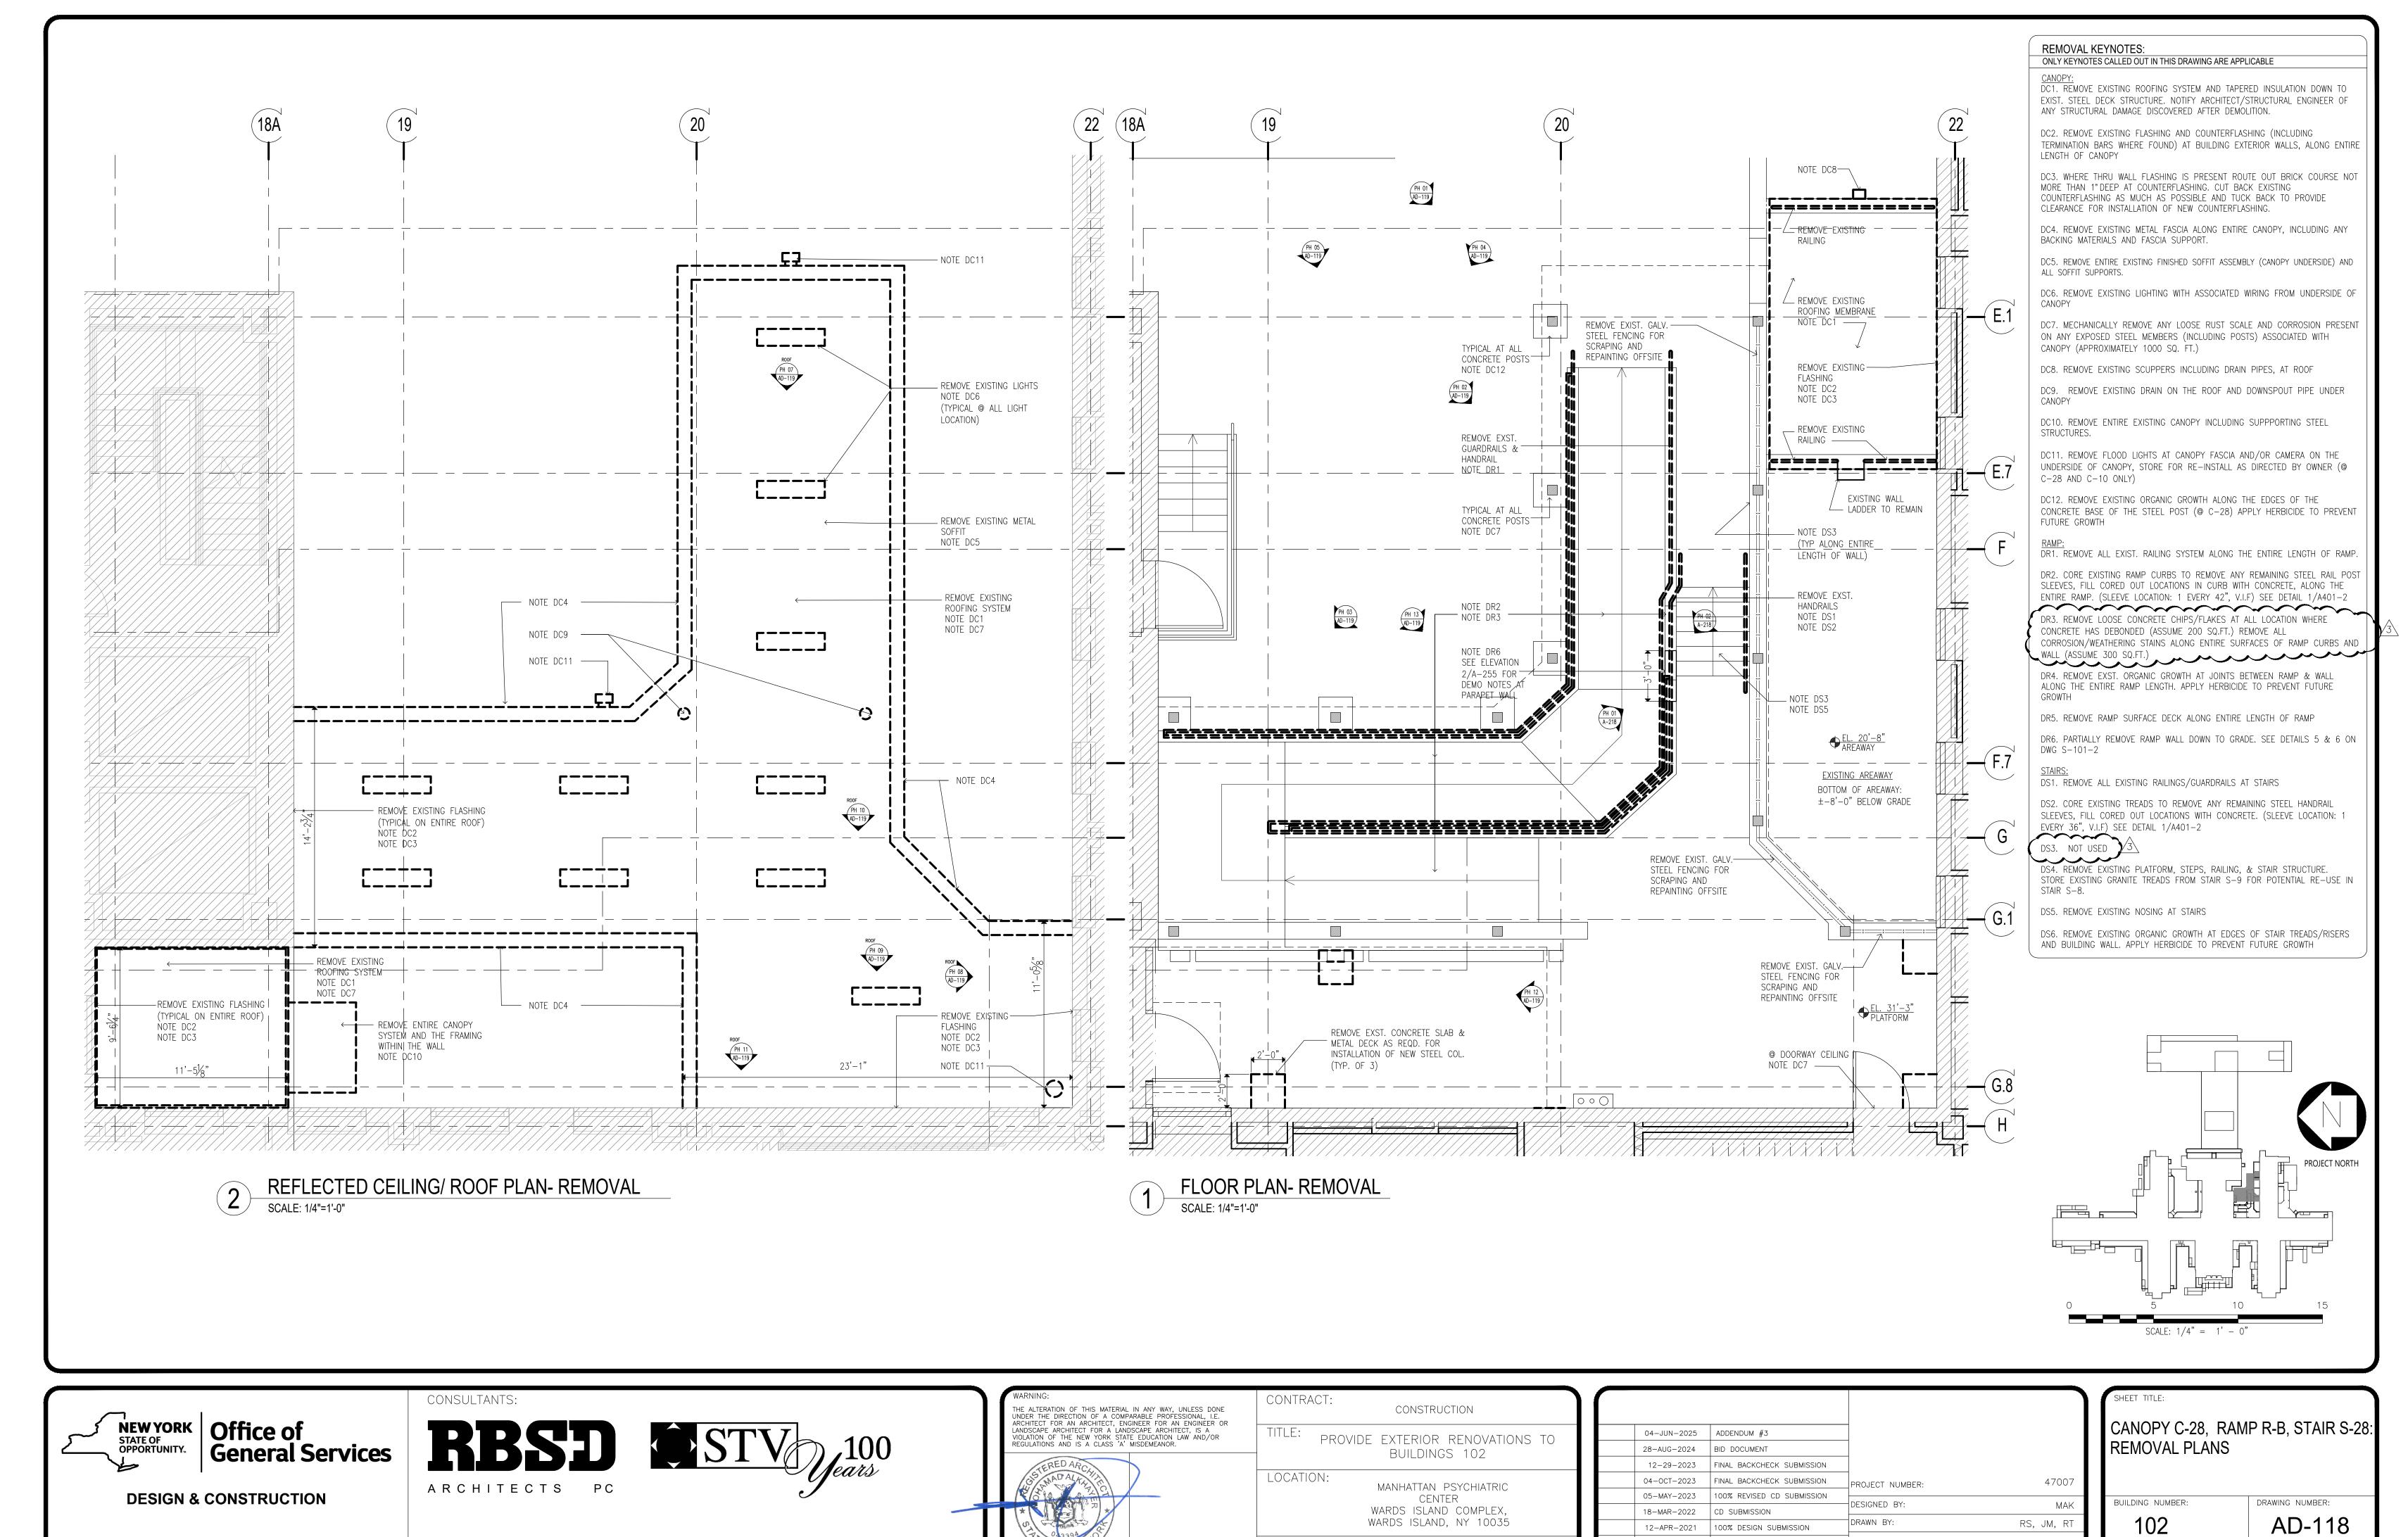
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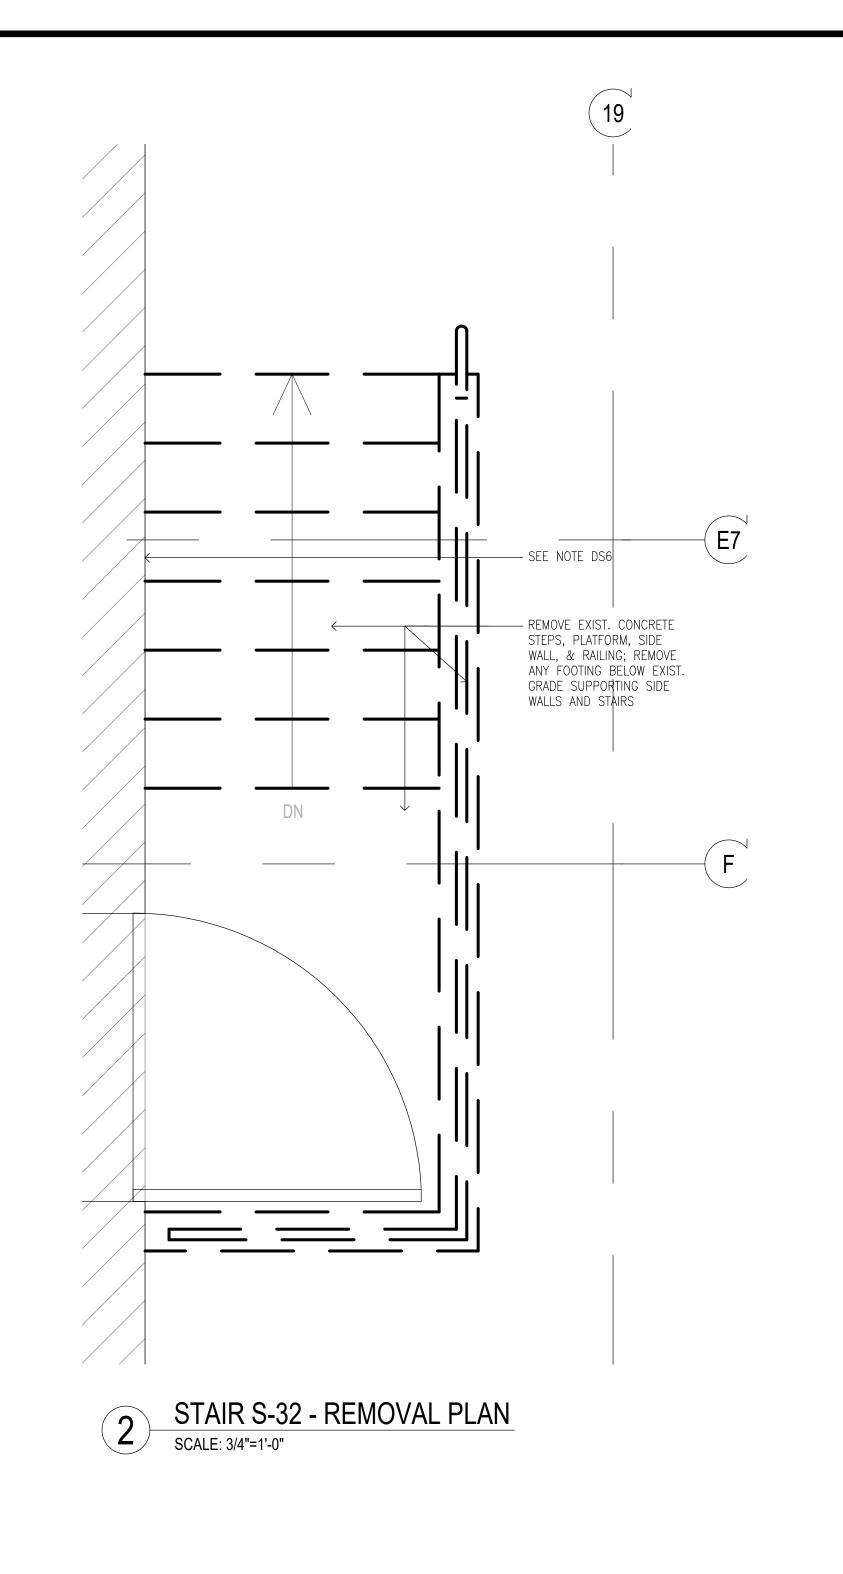
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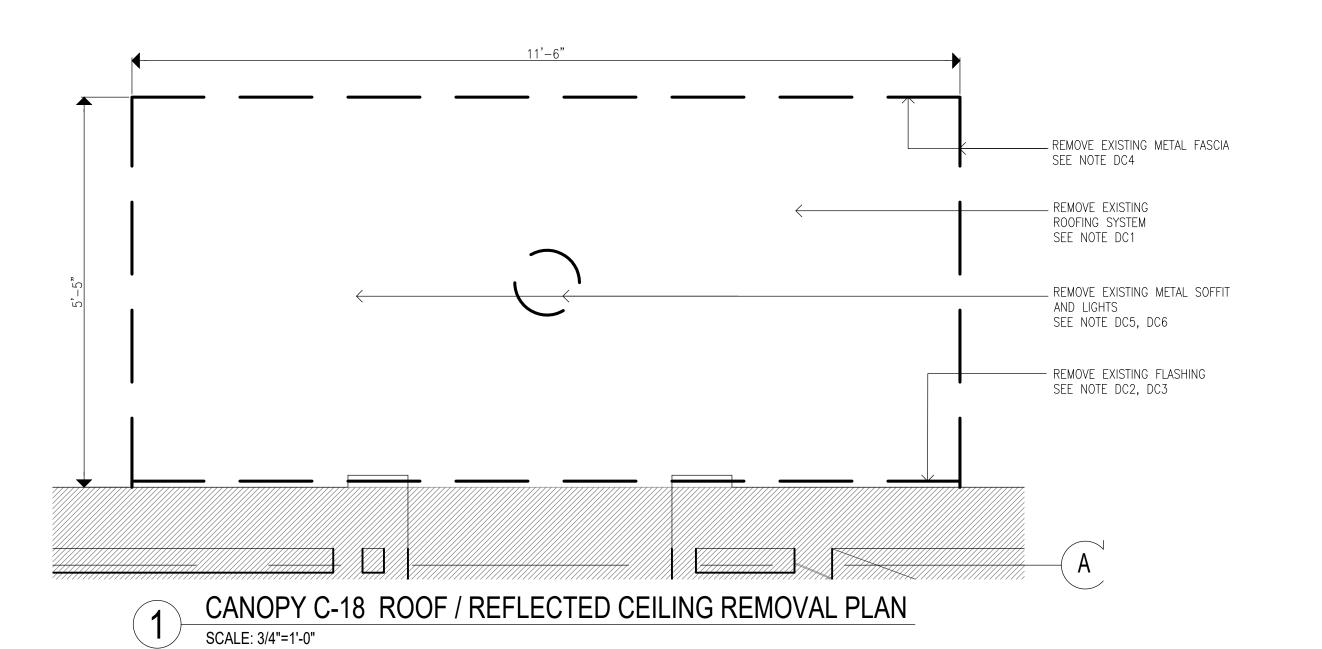
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REMOVAL KEYNOTES:
ONLY KEYNOTES CALLED OUT IN THIS DRAWING ARE APPLICABLE

CANOPY:

DC1. REMOVE EXISTING ROOFING SYSTEM AND TAPERED INSULATION DOWN TO EXIST. STEEL DECK STRUCTURE. NOTIFY ARCHITECT/STRUCTURAL ENGINEER OF

EXIST. STEEL DECK STRUCTURE. NOTIFY ARCHITECT/STRUCTURAL ENGINEER OF ANY STRUCTURAL DAMAGE DISCOVERED AFTER DEMOLITION.

DC2. REMOVE EXISTING FLASHING AND COUNTERFLASHING (INCLUDING

TERMINATION BARS WHERE FOUND) AT BUILDING EXTERIOR WALLS, ALONG ENTIRE

LENGTH OF CANOPY

DC3. WHERE THRU WALL FLASHING IS PRESENT ROUTE OUT BRICK COURSE NOT MORE THAN 1" DEEP AT COUNTERFLASHING. CUT BACK EXISTING COUNTERFLASHING AS MUCH AS POSSIBLE AND TUCK BACK TO PROVIDE

CLEARANCE FOR INSTALLATION OF NEW COUNTERFLASHING.

DC4. REMOVE EXISTING METAL FASCIA ALONG ENTIRE CANOPY, INCLUDING ANY

BACKING MATERIALS AND FASCIA SUPPORT.

DC5. REMOVE ENTIRE EXISTING FINISHED SOFFIT ASSEMBLY (CANOPY UNDERSIDE) AND

ALL SOFFIT SUPPORTS.

DC6. REMOVE EXISTING LIGHTING WITH ASSOCIATED WIRING FROM UNDERSIDE OF

DC7. MECHANICALLY REMOVE ANY LOOSE RUST SCALE AND CORROSION PRESENT ON ANY EXPOSED STEEL MEMBERS (INCLUDING POSTS) ASSOCIATED WITH

CANOPY (APPROXIMATELY 1000 SQ. FT.)

DC8. REMOVE EXISTING SCUPPERS INCLUDING DRAIN PIPES, AT ROOF

DC9. REMOVE EXISTING DRAIN ON THE ROOF AND DOWNSPOUT PIPE UNDER

DC10. REMOVE ENTIRE EXISTING CANOPY INCLUDING SUPPPORTING STEEL STRUCTURES.

DC11. REMOVE FLOOD LIGHTS AT CANOPY FASCIA AND/OR CAMERA ON THE UNDERSIDE OF CANOPY, STORE FOR RE-INSTALL AS DIRECTED BY OWNER (@ C-28 AND C-10 ONLY)

DC12. REMOVE EXISTING ORGANIC GROWTH ALONG THE EDGES OF THE CONCRETE BASE OF THE STEEL POST (@ C-28) APPLY HERBICIDE TO PREVENT FUTURE GROWTH

RAMP: DR1. REMOVE ALL EXIST. RAILING SYSTEM ALONG THE ENTIRE LENGTH OF RAMP.

DR2. CORE EXISTING RAMP CURBS TO REMOVE ANY REMAINING STEEL RAIL POST SLEEVES, FILL CORED OUT LOCATIONS IN CURB WITH CONCRETE, ALONG THE ENTIRE RAMP. (SLEEVE LOCATION: 1 EVERY 42", V.I.F) SEE DETAIL 1/A401-2

DR3. REMOVE LOOSE CONCRETE CHIPS/FLAKES AT ALL LOCATION WHERE CONCRETE HAS DEBONDED (ASSUME 200 SQ.FT.) REMOVE ALL CORROSION/WEATHERING STAINS ALONG ENTIRE SURFACES OF RAMP CURBS AND

WALL (ASSUME 300 SQ.FT.)

DR4. REMOVE EXST. ORGANIC GROWTH AT JOINTS BETWEEN RAMP & WALL ALONG THE ENTIRE RAMP LENGTH. APPLY HERBICIDE TO PREVENT FUTURE GROWTH

DR5. REMOVE RAMP SURFACE DECK ALONG ENTIRE LENGTH OF RAMP

DR6. PARTIALLY REMOVE RAMP WALL DOWN TO GRADE. SEE DETAILS 5 & 6 ON DWG S-101-2

STAIRS:

DS1. REMOVE ALL EXISTING RAILINGS/GUARDRAILS AT STAIRS

DS2. CORE EXISTING TREADS TO REMOVE ANY REMAINING STEEL HANDRAIL


SLEEVES, FILL CORED OUT LOCATIONS WITH CONCRETE. (SLEEVE LOCATION: 1 EVERY 36", V.I.F) SEE DETAIL 1/A401-2

DS3. NOT USED 3

DS4. REMOVE EXISTING PLATFORM, STEPS, RAILING, & STAIR STRUCTURE. STORE EXISTING GRANITE TREADS FROM STAIR S-9 FOR POTENTIAL RE-USE IN STAIR S-8.


DS5. REMOVE EXISTING NOSING AT STAIRS


DS6. REMOVE EXISTING ORGANIC GROWTH AT EDGES OF STAIR TREADS/RISERS AND BUILDING WALL. APPLY HERBICIDE TO PREVENT FUTURE GROWTH

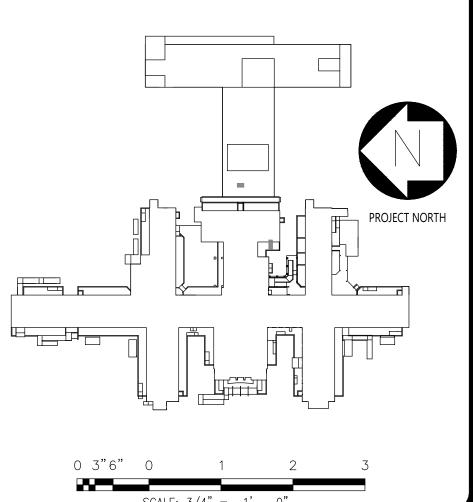







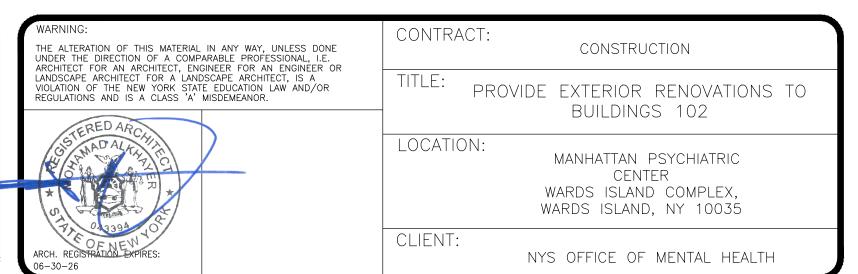

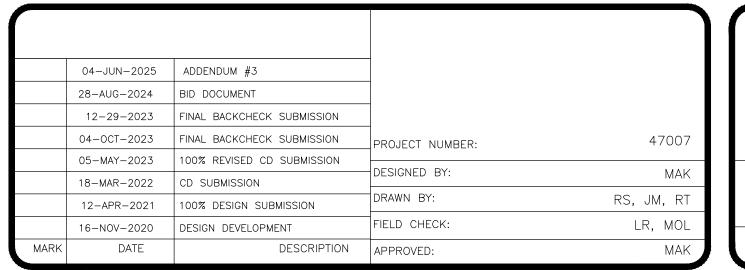

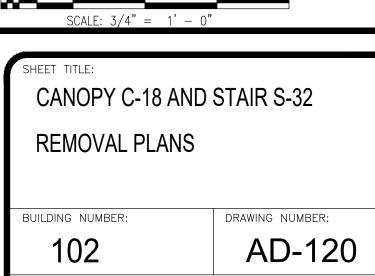

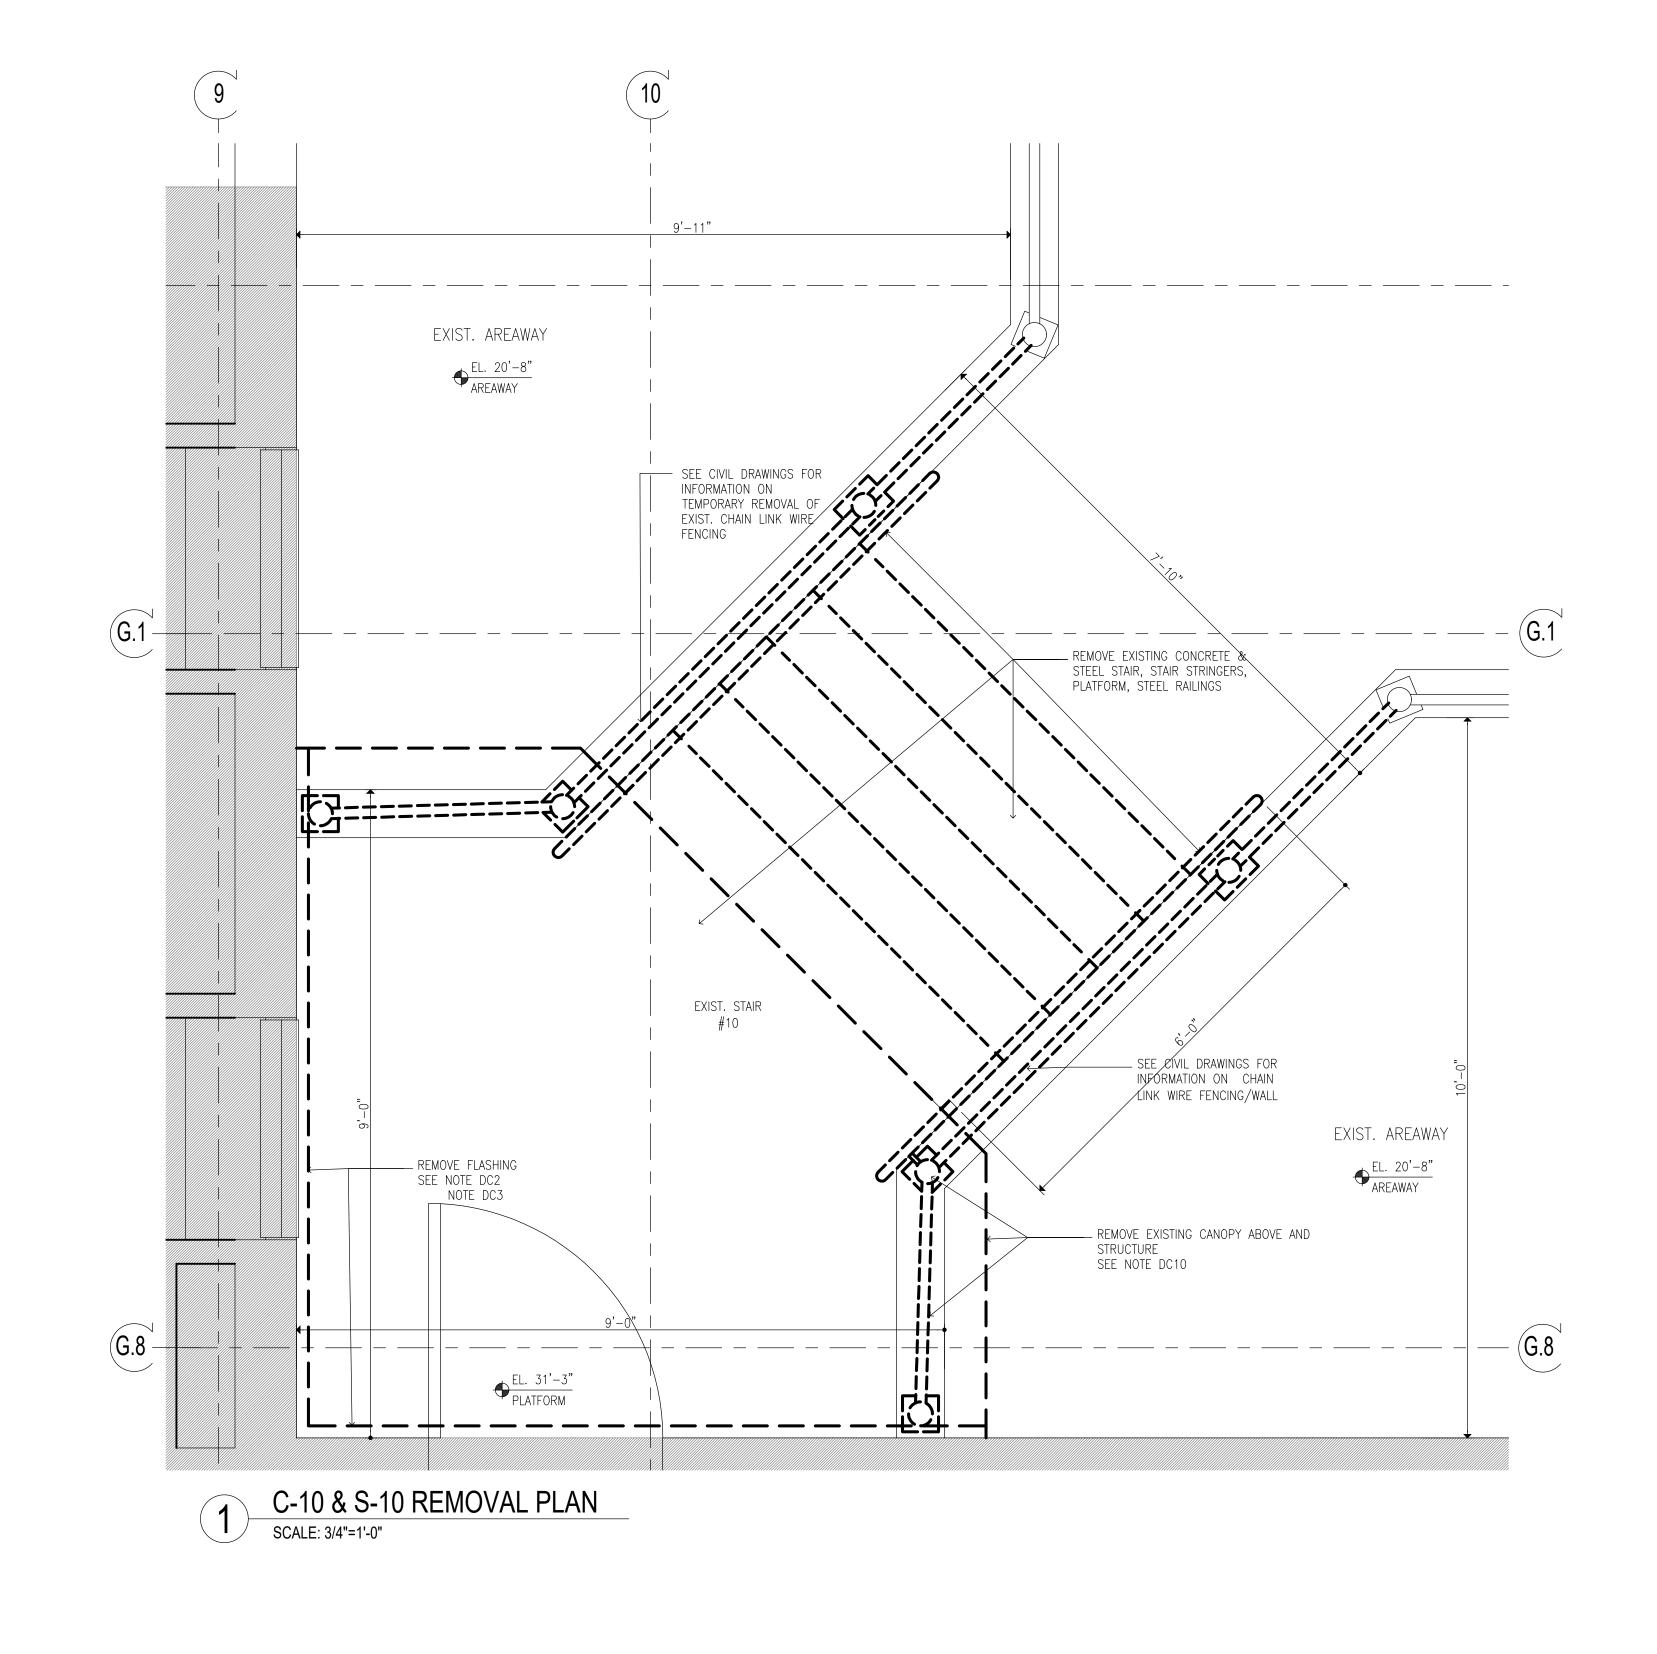

REMOVAL KEYNOTES:

ONLY KEYNOTES CALLED OUT IN THIS DRAWING ARE APPLICABLE

DC1. REMOVE EXISTING ROOFING SYSTEM AND TAPERED INSULATION DOWN TO EXIST. STEEL DECK STRUCTURE. NOTIFY ARCHITECT/STRUCTURAL ENGINEER OF ANY STRUCTURAL DAMAGE DISCOVERED AFTER DEMOLITION.

DC2. REMOVE EXISTING FLASHING AND COUNTERFLASHING (INCLUDING TERMINATION BARS WHERE FOUND) AT BUILDING EXTERIOR WALLS, ALONG ENTIRE

LENGTH OF CANOPY DC3. WHERE THRU WALL FLASHING IS PRESENT ROUTE OUT BRICK COURSE NOT MORE THAN 1" DEEP AT COUNTERFLASHING. CUT BACK EXISTING

COUNTERFLASHING AS MUCH AS POSSIBLE AND TUCK BACK TO PROVIDE

DC4. REMOVE EXISTING METAL FASCIA ALONG ENTIRE CANOPY, INCLUDING ANY BACKING MATERIALS AND FASCIA SUPPORT.

CLEARANCE FOR INSTALLATION OF NEW COUNTERFLASHING.

DC5. REMOVE ENTIRE EXISTING FINISHED SOFFIT ASSEMBLY (CANOPY UNDERSIDE) AND

ALL SOFFIT SUPPORTS. DC6. REMOVE EXISTING LIGHTING WITH ASSOCIATED WIRING FROM UNDERSIDE OF

DC7. MECHANICALLY REMOVE ANY LOOSE RUST SCALE AND CORROSION PRESENT ON ANY EXPOSED STEEL MEMBERS (INCLUDING POSTS) ASSOCIATED WITH

DC8. REMOVE EXISTING SCUPPERS INCLUDING DRAIN PIPES, AT ROOF

CANOPY (APPROXIMATELY 1000 SQ. FT.)

DC9. REMOVE EXISTING DRAIN ON THE ROOF AND DOWNSPOUT PIPE UNDER

DC10. REMOVE ENTIRE EXISTING CANOPY INCLUDING SUPPPORTING STEEL STRUCTURES.

DC11. REMOVE FLOOD LIGHTS AT CANOPY FASCIA AND/OR CAMERA ON THE UNDERSIDE OF CANOPY, STORE FOR RE-INSTALL AS DIRECTED BY OWNER (@ C-28 AND C-10 ONLY)

DC12. REMOVE EXISTING ORGANIC GROWTH ALONG THE EDGES OF THE CONCRETE BASE OF THE STEEL POST (@ C-28) APPLY HERBICIDE TO PREVENT FUTURE GROWTH

DR1. REMOVE ALL EXIST. RAILING SYSTEM ALONG THE ENTIRE LENGTH OF RAMP.

DR2. CORE EXISTING RAMP CURBS TO REMOVE ANY REMAINING STEEL RAIL POST SLEEVES, FILL CORED OUT LOCATIONS IN CURB WITH CONCRETE, ALONG THE ENTIRE RAMP. (SLEEVE LOCATION: 1 EVERY 42", V.I.F) SEE DETAIL 1/A401-2 ENTIRE RAMIF. (SELLYE ECONTION. 1 EVENT 12, .....)

DR3. REMOVE LOOSE CONCRETE CHIPS/FLAKES AT ALL LOCATION WHERE CONCRETE HAS DEBONDED (ASSUME 200 SQ.FT.) REMOVE ALL CORROSION/WEATHERING STAINS ALONG ENTIRE SURFACES OF RAMP CURBS AND WALL (ASSUME 300 SQ.FT.) 

DR4. REMOVE EXST. ORGANIC GROWTH AT JOINTS BETWEEN RAMP & WALL ALONG THE ENTIRE RAMP LENGTH. APPLY HERBICIDE TO PREVENT FUTURE

DR5. REMOVE RAMP SURFACE DECK ALONG ENTIRE LENGTH OF RAMP

DR6. PARTIALLY REMOVE RAMP WALL DOWN TO GRADE. SEE DETAILS 5 & 6 ON DWG S-101-2

DS1. REMOVE ALL EXISTING RAILINGS/GUARDRAILS AT STAIRS


DS2. CORE EXISTING TREADS TO REMOVE ANY REMAINING STEEL HANDRAIL SLEEVES, FILL CORED OUT LOCATIONS WITH CONCRETE. (SLEEVE LOCATION: 1

DS3. NOT USED 3

DS4. REMOVE EXISTING PLATFORM, STEPS, RAILING, & STAIR STRUCTURE. STORE EXISTING GRANITE TREADS FROM STAIR S-9 FOR POTENTIAL RE-USE IN STAIR S-8.

DS5. REMOVE EXISTING NOSING AT STAIRS

DS6. REMOVE EXISTING ORGANIC GROWTH AT EDGES OF STAIR TREADS/RISERS AND BUILDING WALL. APPLY HERBICIDE TO PREVENT FUTURE GROWTH

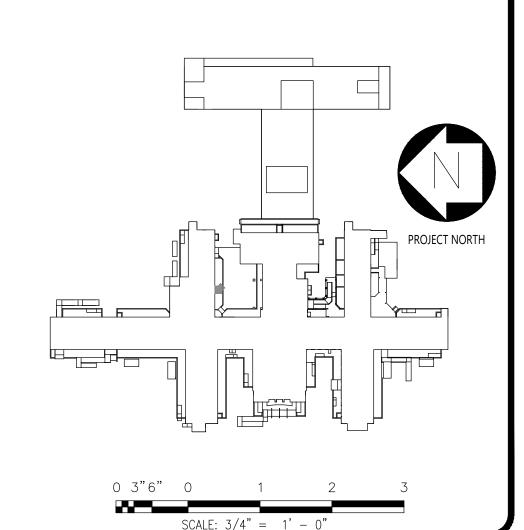



NEW YORK STATE OF OPPORTUNITY.


Office of General Services

**DESIGN & CONSTRUCTION** 




CERTIFICATE OF AUTHORIZATION PSC #006203



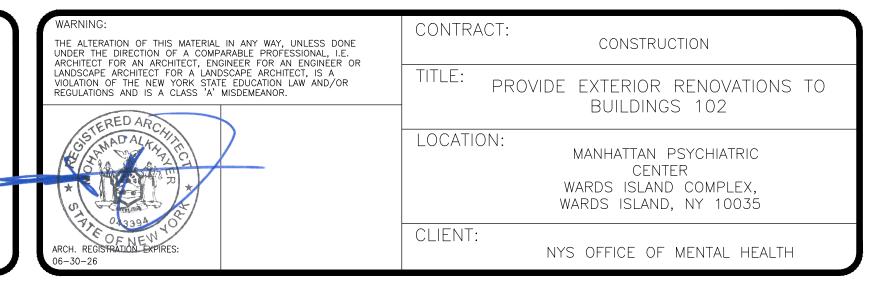


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	28-AUG-2024	BID DOCUMENT		
	12-29-2023	FINAL BACKCHECK SUBMISSION		
	04-OCT-2023	FINAL BACKCHECK SUBMISSION	PROJECT NUMBER:	47007
	05-MAY-2023	100% REVISED CD SUBMISSION	DECIONED DV.	NANZ
	18-MAR-2022	CD SUBMISSION	DESIGNED BY:	MAK
	12-APR-2021	100% DESIGN SUBMISSION	DRAWN BY:	RS, JM, RT
	16-NOV-2020	DESIGN DEVELOPMENT	FIELD CHECK:	LR, MOL
MARK	DATE	DESCRIPTION	APPROVED:	MAK

SHEET TITLE: CANOPY C-10, STAIRS S-10: REMOVAL PLAN BUILDING NUMBER DRAWING NUMBER: AD-122

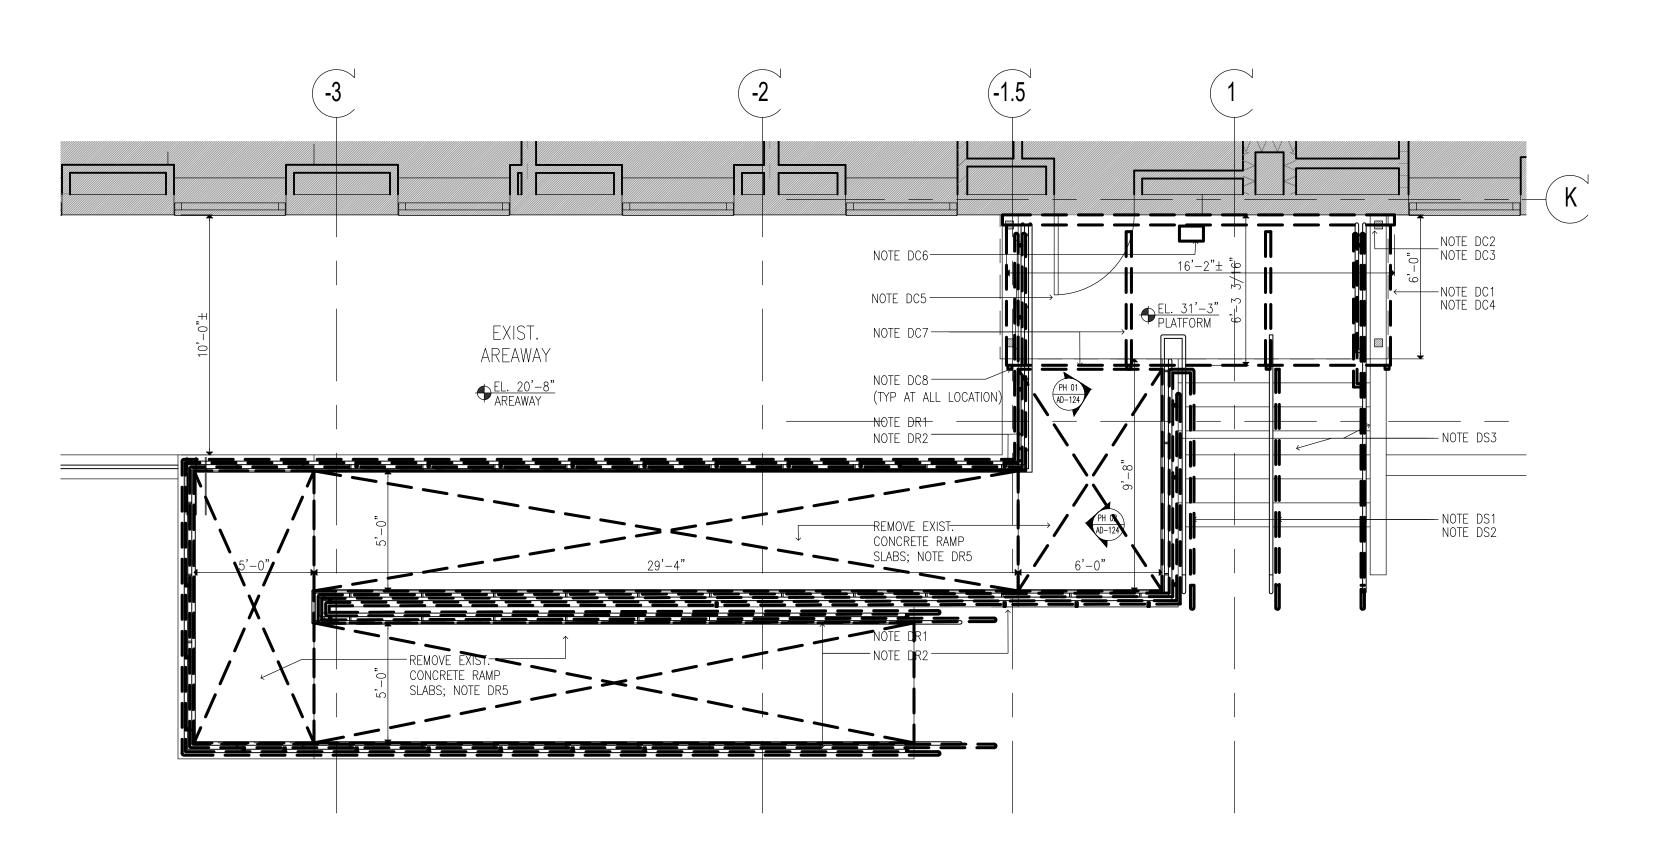


CANOPY C-29, STAIR S-29 & RAMP R-D REMOVAL PLAN SCALE: 1/4"=1'-0"



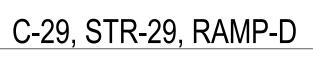



C-29, STR-29, RAMP-D

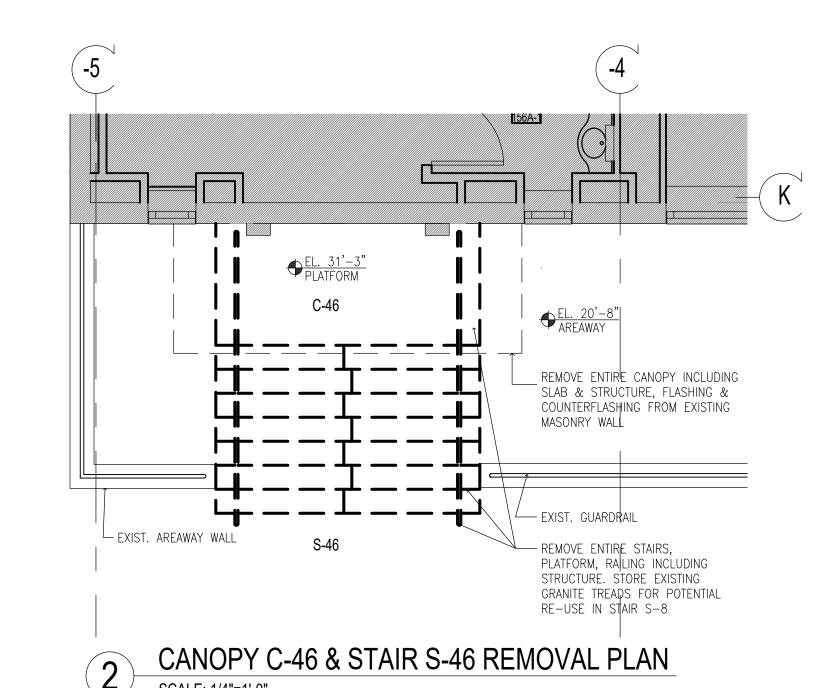

PHOTOGRAPHS PROVIDED IN THE CONTRACT DOCUMENTS ARE FOR REFERENCE PURPOSES ONLY. THESE PHOTOS REPRESENT WHAT CONDITIONS WERE AT THE TIME THEY WERE TAKEN AND MAY NOT ACCURATELY REPRESENT CURRENT CONDITIONS

DC8. REMOVE EXISTING SCUPPERS INCLUDING DRAIN PIPES, AT ROOF DC9. REMOVE EXISTING DRAIN ON THE ROOF AND DOWNSPOUT PIPE UNDER DC10. REMOVE ENTIRE EXISTING CANOPY INCLUDING SUPPPORTING STEEL STRUCTURES. DC11. REMOVE FLOOD LIGHTS AT CANOPY FASCIA AND/OR CAMERA ON THE UNDERSIDE OF CANOPY, STORE FOR RE-INSTALL AS DIRECTED BY OWNER (@ C-28 AND C-10 ONLY) DC12. REMOVE EXISTING ORGANIC GROWTH ALONG THE EDGES OF THE CONCRETE BASE OF THE STEEL POST (@ C-28) APPLY HERBICIDE TO PREVENT FUTURE GROWTH DR1. REMOVE ALL EXIST. RAILING SYSTEM ALONG THE ENTIRE LENGTH OF RAMP. DR2. CORE EXISTING RAMP CURBS TO REMOVE ANY REMAINING STEEL RAIL POST SLEEVES, FILL CORED OUT LOCATIONS IN CURB WITH CONCRETE, ALONG THE ENTIRE RAMP. (SLEEVE LOCATION: 1 EVERY 42", V.I.F) SEE DETAIL 1/A401-2 ENTIRE NAME: (SELEVE ECONTION: 1 EVENT .....) DR3. REMOVE LOOSE CONCRETE CHIPS/FLAKES AT ALL LOCATION WHERE CONCRETE HAS DEBONDED (ASSUME 200 SQ.FT.) REMOVE ALL CORROSION/WEATHERING STAINS ALONG ENTIRE SURFACES OF RAMP CURBS AND DD4 DD51 DR4. REMOVE EXST. ORGANIC GROWTH AT JOINTS BETWEEN RAMP & WALL ALONG THE ENTIRE RAMP LENGTH. APPLY HERBICIDE TO PREVENT FUTURE DR5. REMOVE RAMP SURFACE DECK ALONG ENTIRE LENGTH OF RAMP DR6. PARTIALLY REMOVE RAMP WALL DOWN TO GRADE. SEE DETAILS 5 & 6 ON DWG S-101-2 DS1. REMOVE ALL EXISTING RAILINGS/GUARDRAILS AT STAIRS DS2. CORE EXISTING TREADS TO REMOVE ANY REMAINING STEEL HANDRAIL SLEEVES, FILL CORED OUT LOCATIONS WITH CONCRETE. (SLEEVE LOCATION: 1 EVERY 36", V.I.F) SEE DETAIL 1/A401-2 DS3. NOT USED DS4. REMOVE EXISTING PLATFORM, STEPS, RAILING, & STAIR STRUCTURE. STORE EXISTING GRANITE TREADS FROM STAIR S-9 FOR POTENTIAL RE-USE IN DS5. REMOVE EXISTING NOSING AT STAIRS DS6. REMOVE EXISTING ORGANIC GROWTH AT EDGES OF STAIR TREADS/RISERS AND BUILDING WALL. APPLY HERBICIDE TO PREVENT FUTURE GROWTH

REMOVAL KEYNOTES:

LENGTH OF CANOPY

ALL SOFFIT SUPPORTS.

ONLY KEYNOTES CALLED OUT IN THIS DRAWING ARE APPLICABLE

ANY STRUCTURAL DAMAGE DISCOVERED AFTER DEMOLITION.

DC1. REMOVE EXISTING ROOFING SYSTEM AND TAPERED INSULATION DOWN TO EXIST. STEEL DECK STRUCTURE. NOTIFY ARCHITECT/STRUCTURAL ENGINEER OF

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DC5. REMOVE ENTIRE EXISTING FINISHED SOFFIT ASSEMBLY (CANOPY UNDERSIDE) AND

DC6. REMOVE EXISTING LIGHTING WITH ASSOCIATED WIRING FROM UNDERSIDE OF

DC7. MECHANICALLY REMOVE ANY LOOSE RUST SCALE AND CORROSION PRESENT

ON ANY EXPOSED STEEL MEMBERS (INCLUDING POSTS) ASSOCIATED WITH

DC2. REMOVE EXISTING FLASHING AND COUNTERFLASHING (INCLUDING

MORE THAN 1" DEEP AT COUNTERFLASHING. CUT BACK EXISTING

CLEARANCE FOR INSTALLATION OF NEW COUNTERFLASHING.

BACKING MATERIALS AND FASCIA SUPPORT.

CANOPY (APPROXIMATELY 1000 SQ. FT.)

COUNTERFLASHING AS MUCH AS POSSIBLE AND TUCK BACK TO PROVIDE

NEW YORK
STATE OF
OPPORTUNITY.
General Services

**DESIGN & CONSTRUCTION** 

CONSULTANTS:

CERTIFICATE OF AUTHORIZATION PSC #006203



WARNING:  THE ALTERATION OF THIS MATERIAL IN ANY WAY, UNLESS DONE UNDER THE DIRECTION OF A COMPARABLE PROFESSIONAL, I.E. ARCHITECT FOR AN ARCHITECT FOR AN ENGINEER OR	CONTRACT: CONSTRUCTION
UNDER THE DIRECTION OF A COMPARABLE PROFESSIONAL, I.E. ARCHITECT FOR AN ARCHITECT, ENGINEER FOR AN ENGINEER OR LANDSCAPE ARCHITECT FOR A LANDSCAPE ARCHITECT, IS A VIOLATION OF THE NEW YORK STATE EDUCATION LAW AND/OR REGULATIONS AND IS A CLASS 'A' MISDEMEANOR.	TITLE: PROVIDE EXTERIOR RENOVATIONS TO BUILDINGS 102
STERED ARCHITA	LOCATION:  MANHATTAN PSYCHIATRIC CENTER WARDS ISLAND COMPLEX, WARDS ISLAND, NY 10035
ARCH. REGISTRATION EXPIRES: 06-30-26	CLIENT:  NYS OFFICE OF MENTAL HEALTH

	04-JUN-2025	ADDENDUM #3		
	28-AUG-2024	BID DOCUMENT	]	
	12-29-2023	FINAL BACKCHECK SUBMISSION		
	04-OCT-2023	FINAL BACKCHECK SUBMISSION	PROJECT NUMBER:	47007
	05-MAY-2023	100% REVISED CD SUBMISSION	DECIONED DV	
	18-MAR-2022	CD SUBMISSION	DESIGNED BY:	MAK
	12-APR-2021	100% DESIGN SUBMISSION	DRAWN BY:	RS, JM, RT
	16-NOV-2020	DESIGN DEVELOPMENT	FIELD CHECK:	LR, MOL
MARK	DATE	DESCRIPTION	APPROVED:	MAK


SHEET TITLE: CANOPY C-29, STAIRS S-29, RAMP R-D, CANOPY C-46 & STAIR S-46

REMOVAL PLANS

SHEET

SCALE: 1/4" = 1' -

DRAWING NUMBER: AD-124

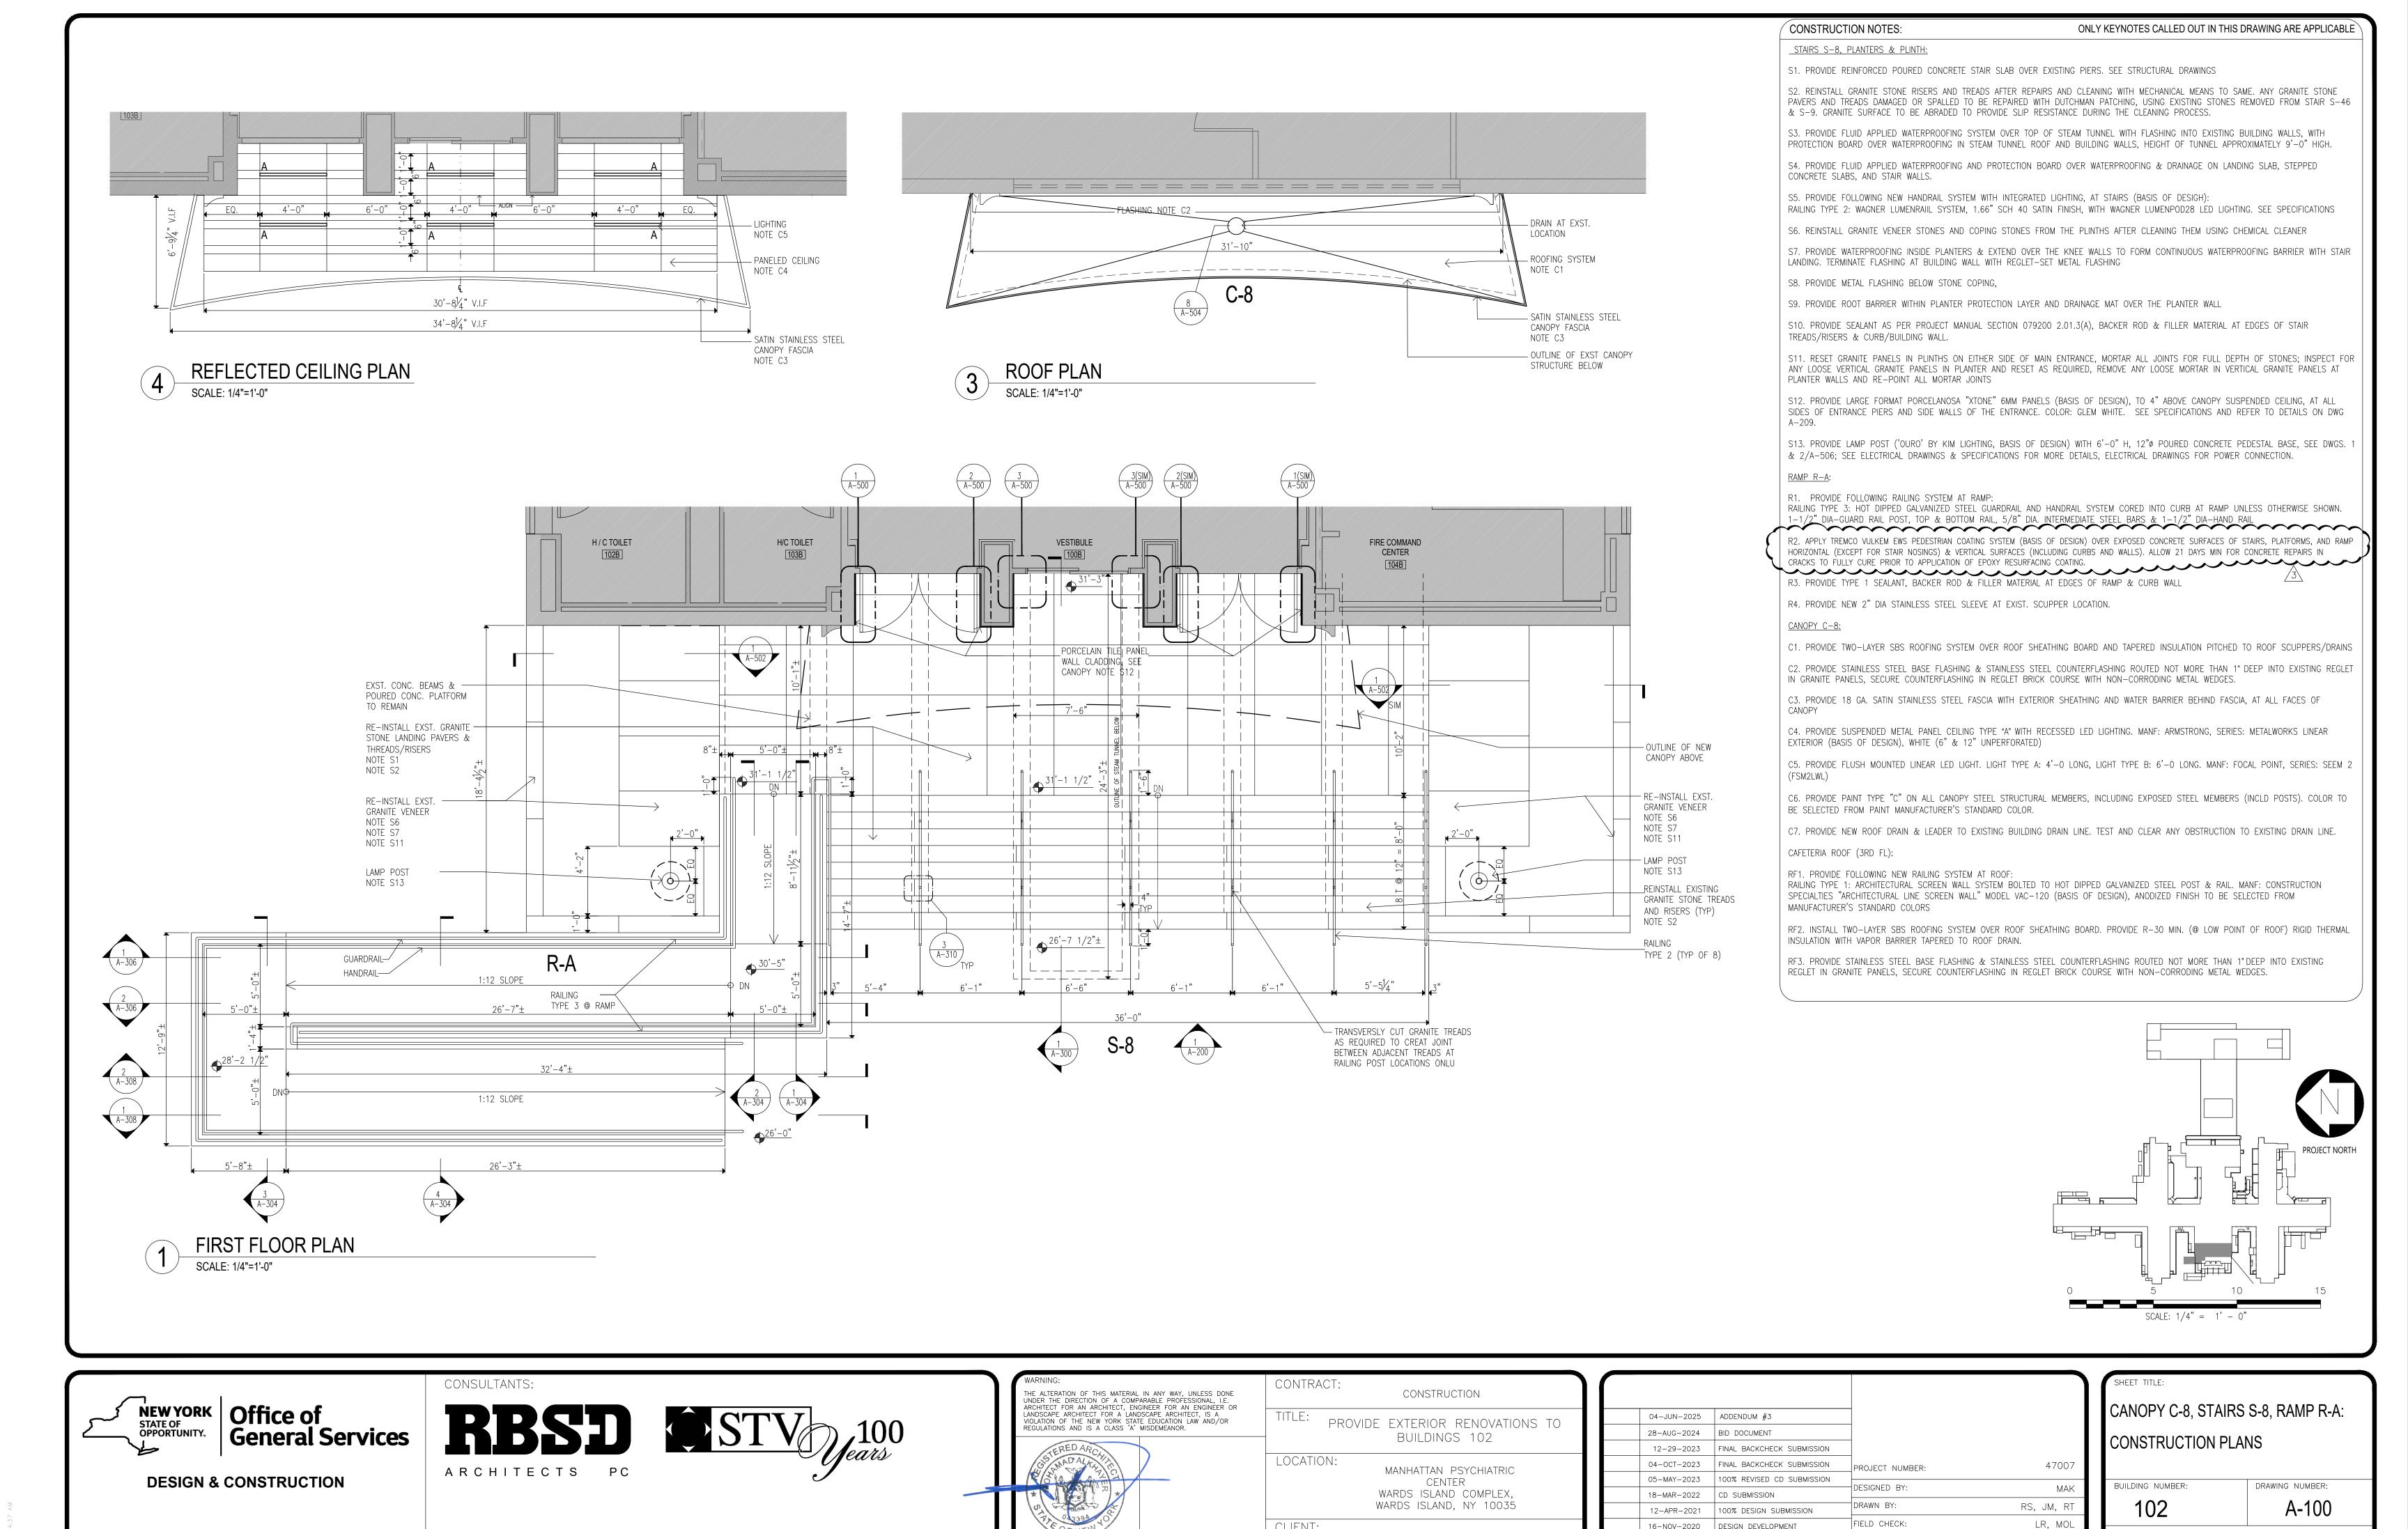

NYS OFFICE OF MENTAL HEALTH

LR, MOL


MAK

16-NOV-2020

DATE

DESIGN DEVELOPMENT

DESCRIPTION | APPROVED:

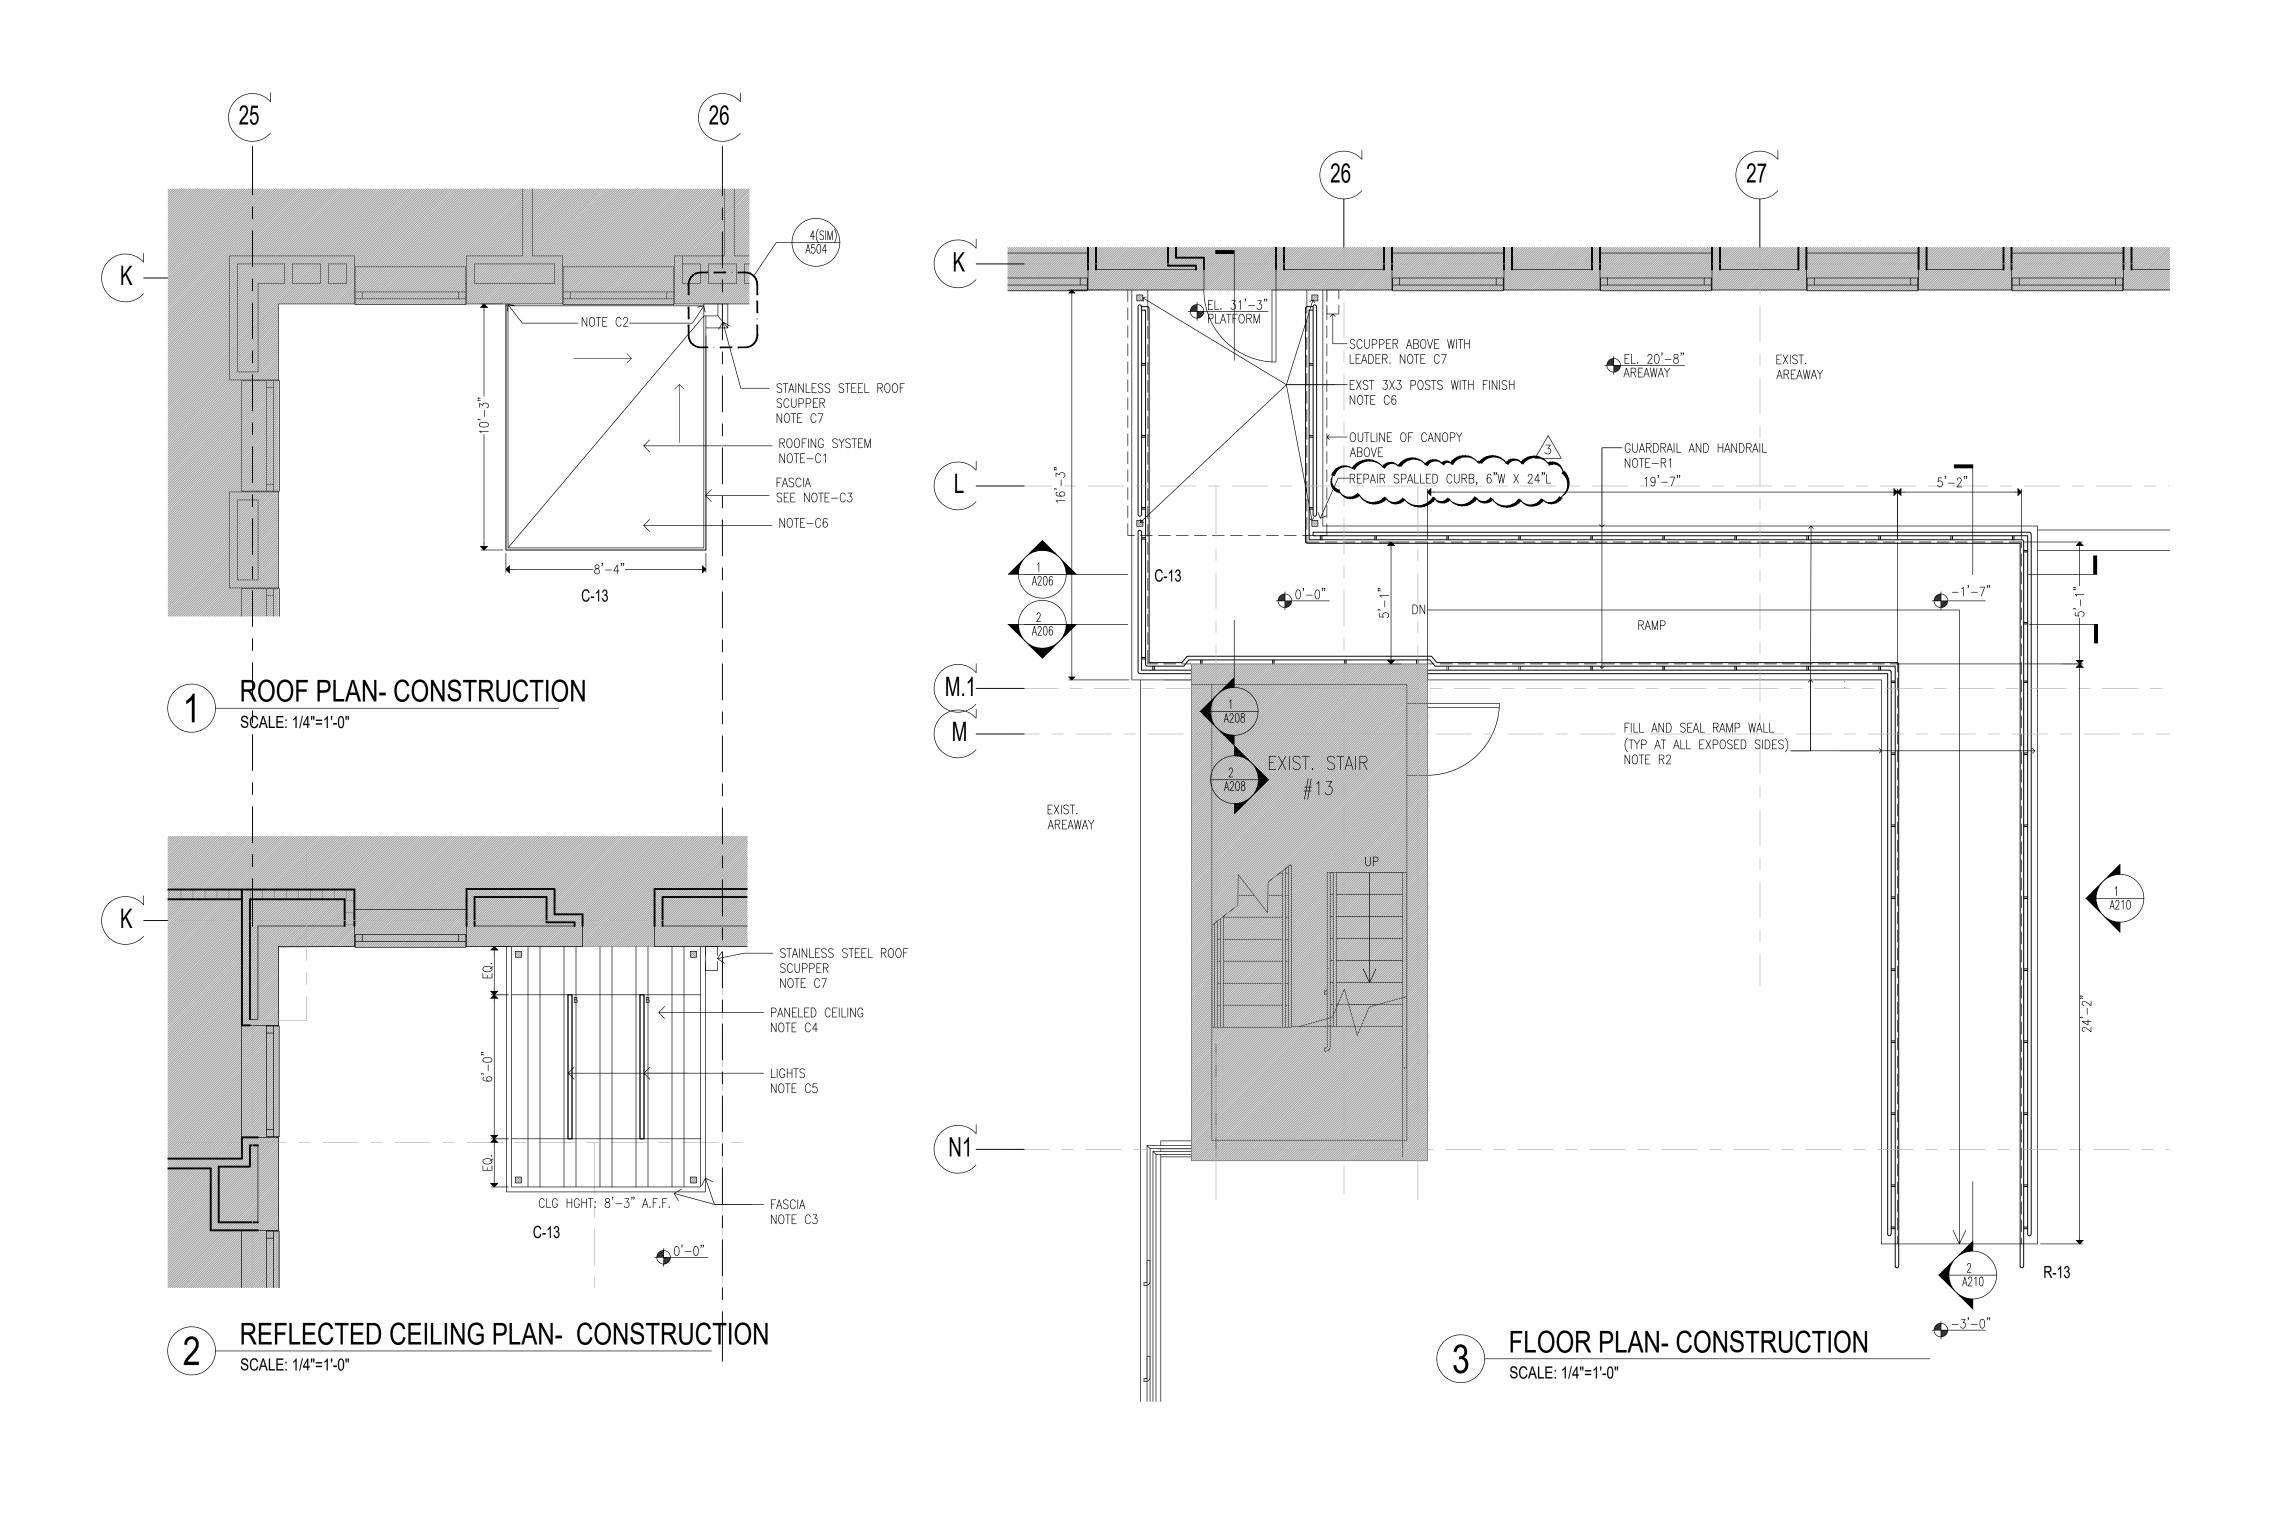



C1. PROVIDE TWO-LAYER SBS ROOFING SYSTEM OVER ROOF SHEATHING BOARD

AND TAPERED INSULATION PITCHED TO ROOF SCUPPERS C1A. PROVIDE TWO-LAYER SBS ROOFING SYSTEM OVER ROOF SHEATHING BOARD, TAPERED INSULATION PITCHED TO DRAINS, AND PROVIDE R-30 MIN.(@

C2. PROVIDE STAINLESS STEEL BASE FLASHING & STAINLESS STEEL COUNTERFLASHING INSTALLED IN REGLET NOT MORE THAN 1" DEEP INTO ONE HORIZONTAL BRICK COURSE 12" MIN. ABOVE FINISHED SURFACE OF ROOF, SECURE COUNTERFLASHING IN REGLET BRICK COURSE WITH NON-CORRODING METAL WEDGES. COUNTERFLASHING TO BE SET INTO EXISTING REGLET ON

LOW POINT OF ROOF) RIGID THERMAL INSULATION WITH VAPOR BARRIER.

C3. PROVIDE 18 GA. SATIN STAINLESS STEEL FASCIA WITH EXTERIOR SHEATHING AND WATER BARRIER BEHIND FASCIA, AT ALL FACES OF CANOPY

C4. PROVIDE SUSPENDED METAL PANEL CEILING TYPE "A" WITH RECESSED LED LIGHTING. MANF: ARMSTRONG, SERIES: METALWORKS LINEAR EXTERIOR, WHITE (6"&12" UNPERFORATED) (BASIS OF DESIGN)

C5. PROVIDE FLUSH MOUNTED LINEAR LED LIGHT. LIGHT TYPE A: 4'-0 LONG, LIGHT TYPE B: 6'-0 LONG. MANF: FOCAL POINT, SERIES: SEEM 2 (FSM2LWL) (BASIS OF DESIGN)

C6. PROVIDE PAINT TYPE "C" (SEE PROJECT MANUAL) ON ALL CANOPY STEEL STRUCTURAL MEMBERS, INCLUDING EXPOSED STEEL MEMBERS (INCLD POSTS). COLOR TO BE SELECTED FROM PAINT MANUFACTURER'S STANDARD COLOR.

C7. PROVIDE STAINLESS STEEL ROOF SCUPPER WITH LEADER TO GRADE OR BOTTOM OF AREAWAY TERMINATING IN PRECAST CONCRETE SPLASH BLOCK SET AWAY FROM MASONRY WALL

C8. PROVIDE REINFORCED CONCRETE CANOPY. SEE STRUCTURAL DRAWINGS

MASONRY WALL.

R1. PROVIDE HOT DIPPED GALVANIZED STEEL GUARDRAIL AND HANDRAIL SYSTEM CORED INTO CURB AT RAMP OR STAIRS UNLESS OTHERWISE SHOWN. 1-1/2" DIA-GUARD RAIL POST, TOP & BOTTOM RAIL, 5/8" DIA. INTERMEDIATE STEEL 

R2. ALLOW 21 DAYS MIN FOR CONCRETE REPAIRS IN TO FULLY CURE PRIOR TO APPLICATION OF RESURFACING COATING, APPLY TREMCO "VULKEM EWS SYSTEM" OVER EXPOSED CONCRETE SURFACES OF EXISTING AND NEW STAIRS PLATFORMS, AND RAMP WALKING SURFACES (INCLUDING CURBS AND WALLS).

BACKER ROD & FILLER MATERIAL AT EDGES OF STAIR TREADS/RISERS & CURB/BUILDING WALL.

R4. PROVIDE REINFORCED CONCRETE RAMP SLAB/DECK. SEE STRUCTURAL


S1. PROVIDE HOT DIPPED GALVANIZED STEEL GUARDRAIL AND HANDRAIL SYSTEM CORED INTO CURB AT RAMP OR STAIRS UNLESS OTHERWISE SHOWN. 1-1/2" DIA-GUARD RAIL POST, TOP & BOTTOM RAIL, 5/8" DIA- INTERMEDIATE STEEL BARS & 1-1/2" DIA-HAND RAIL

S2. PROVIDE REINFORCED CONCRETE STAIRS, LANDING AND CURB, AS NOTED ON DRAWING. SEE STRUCTURAL DRAWINGS

S3. PROVIDE CAST IN PLACE ABRASIVE NOSING AT ALL NEW STAIR STEP EDGES.

S4. APPLY TREMCO "VULKEM EWS SYSTEM" OVER EXPOSED CONCRETE SURFACES OF EXISTING AND NEW STAIRS, PLATFORMS, AND RAMP WALKING SURFACES (INCLUDING CURBS AND WALLS). 

2.01.3(A), BACKER ROD & FILLER MATERIAL AT EDGES OF STAIR TREADS/RISERS & CURB/BUILDING WALL.

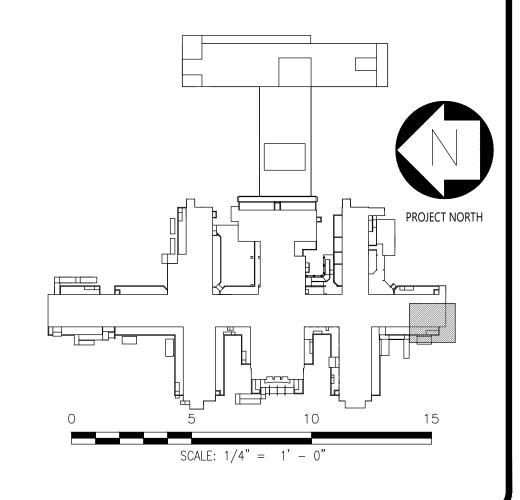



NEW YORK STATE OF OPPORTUNITY.

Office of General Services

**DESIGN & CONSTRUCTION** 



CERTIFICATE OF AUTHORIZATION PSC #006203




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1	W CARROLL CARR	LOCATION:  MANHATTAN PSYCHIATRIC  CENTER  WARDS ISLAND COMPLEX,  WARDS ISLAND, NY 10035
	ARCH. REGISTRATION EXPIRES: 06–30–26	CLIENT:  NYS OFFICE OF MENTAL HEALTH


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	28-AUG-2024	BID DOCUMENT			
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	05-MAY-2023	100% REVISED CD SUBMISSION	DECICNED DV		•
	18-MAR-2022	CD SUBMISSION	DESIGNED BY:	MAK	
	12-APR-2021	100% DESIGN SUBMISSION	DRAWN BY:	RS, JM, RT	
	16-NOV-2020	DESIGN DEVELOPMENT	FIELD CHECK:	LR, MOL	
MARK	DATE	DESCRIPTION	APPROVED:	MAK	•

CANOPY C-13, RAMP R-13:
FLOOR AND REFLECTED CEILING
PLANS

BUILDING NUMBER: A-106

SHEET

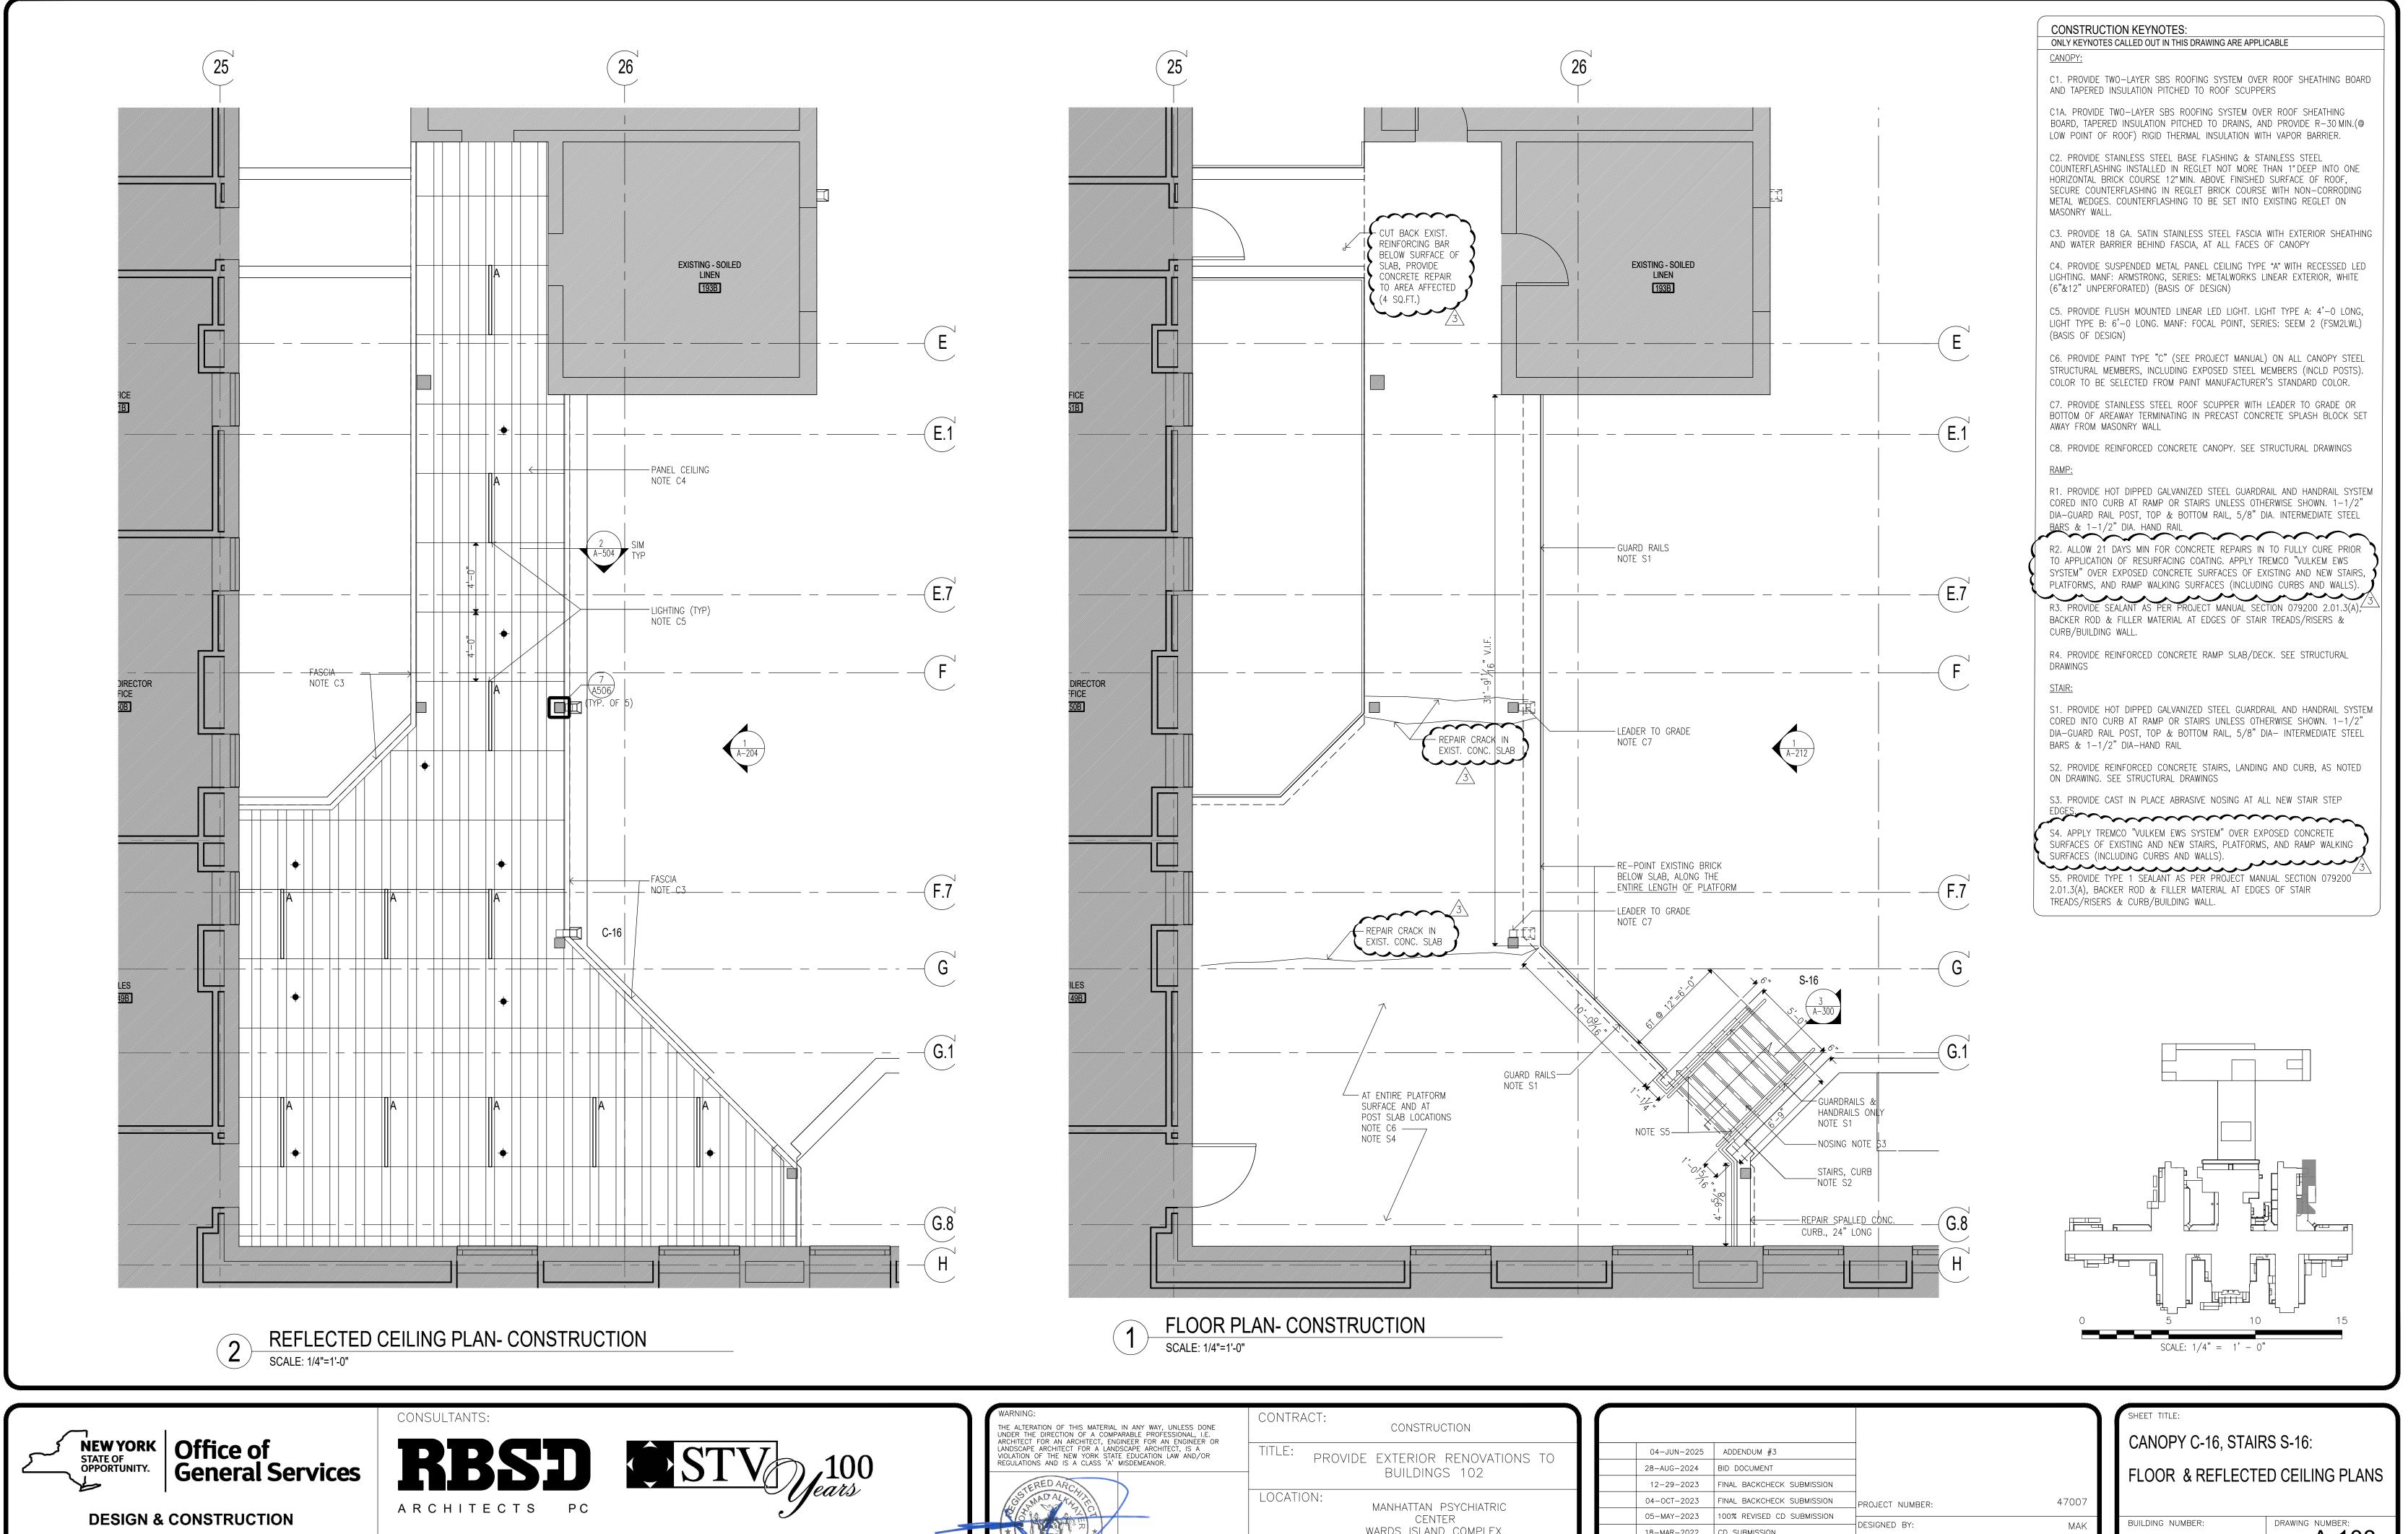

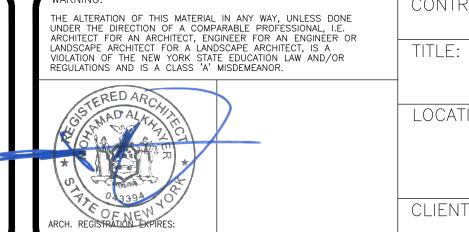


CERTIFICATE OF AUTHORIZATION PSC #006203

DONE , I.E. EER OR	CONSTRUCTION
A D/OR	TITLE: PROVIDE EXTERIOR RENOVATIONS TO BUILDINGS 102
	LOCATION:  MANHATTAN PSYCHIATRIC  CENTER  WARDS ISLAND COMPLEX,  WARDS ISLAND, NY 10035
	CLIENT:  NYS OFFICE OF MENTAL HEALTH

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	16-NOV-2020	DESIGN DEVELOPMENT	FIELD CHECK:	LR, MOL
MARK	DATE	DESCRIPTION	APPROVED:	MAK

A-108

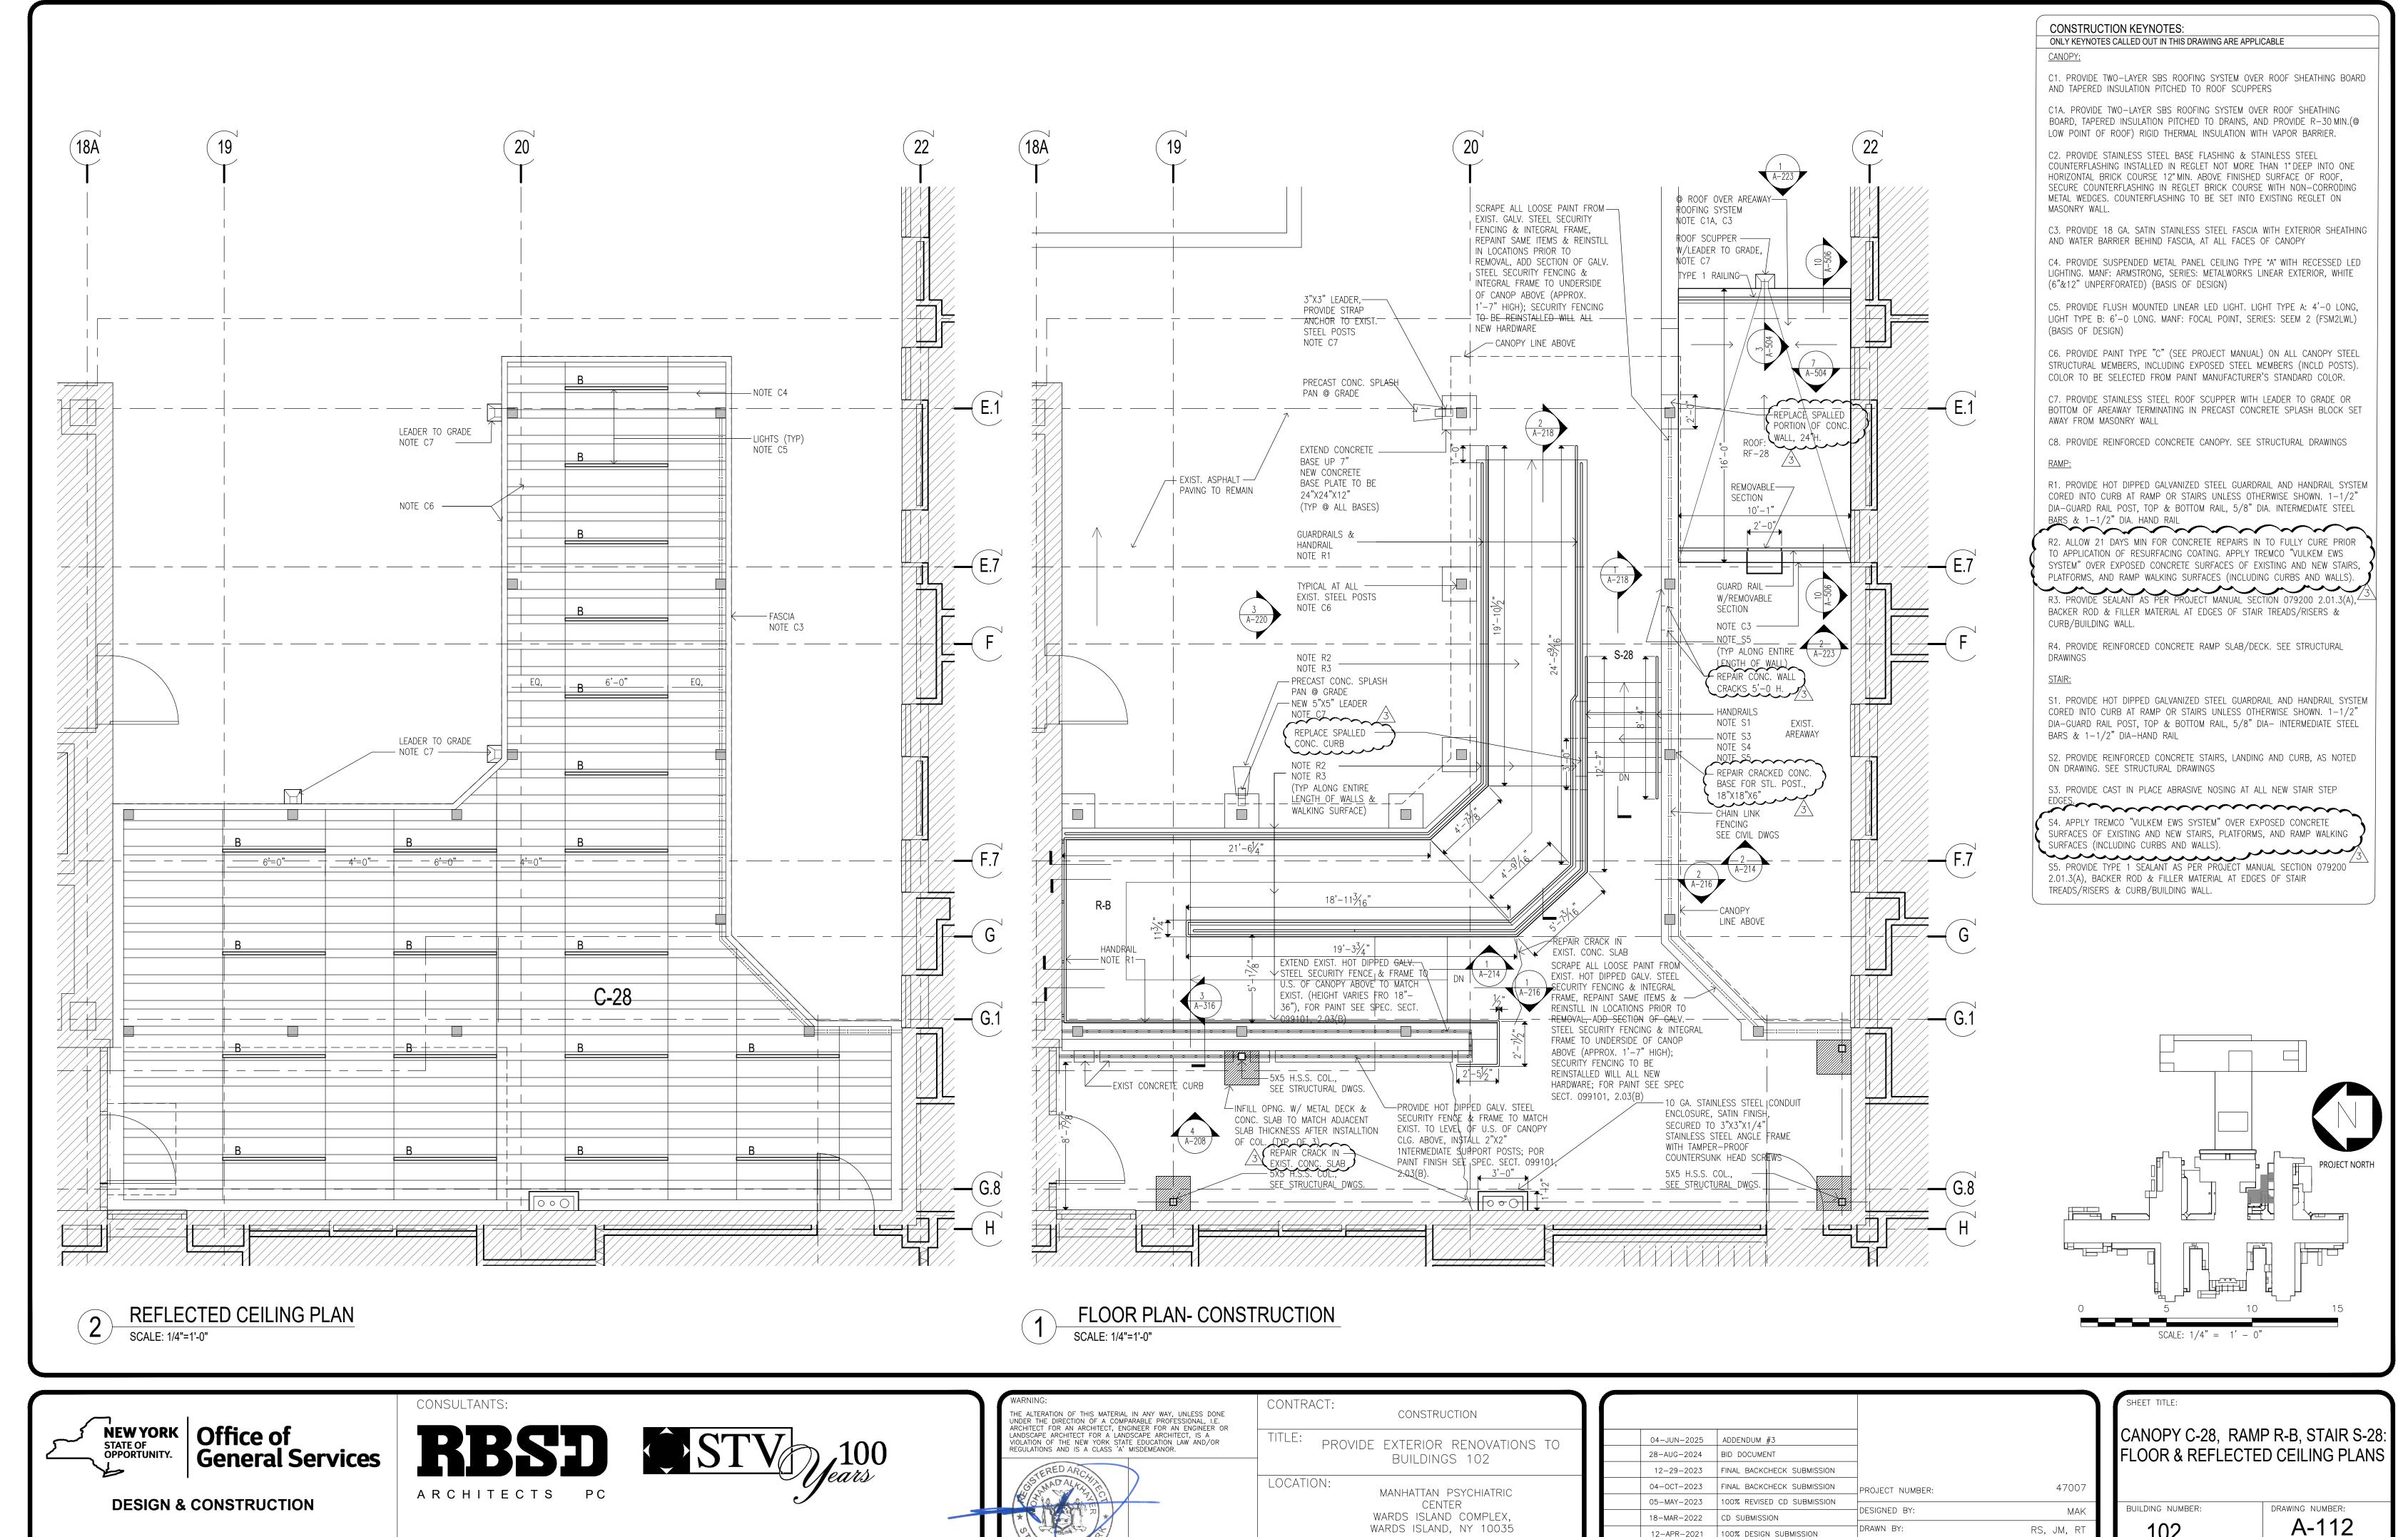

WARDS ISLAND, NY 10035

NYS OFFICE OF MENTAL HEALTH

CLIENT:

PRAWN BY:

FIELD CHECK:

100% DESIGN SUBMISSION

DESIGN DEVELOPMENT


12-APR-2021

16-NOV-2020

RS, JM, R

LR, MOL

MAK

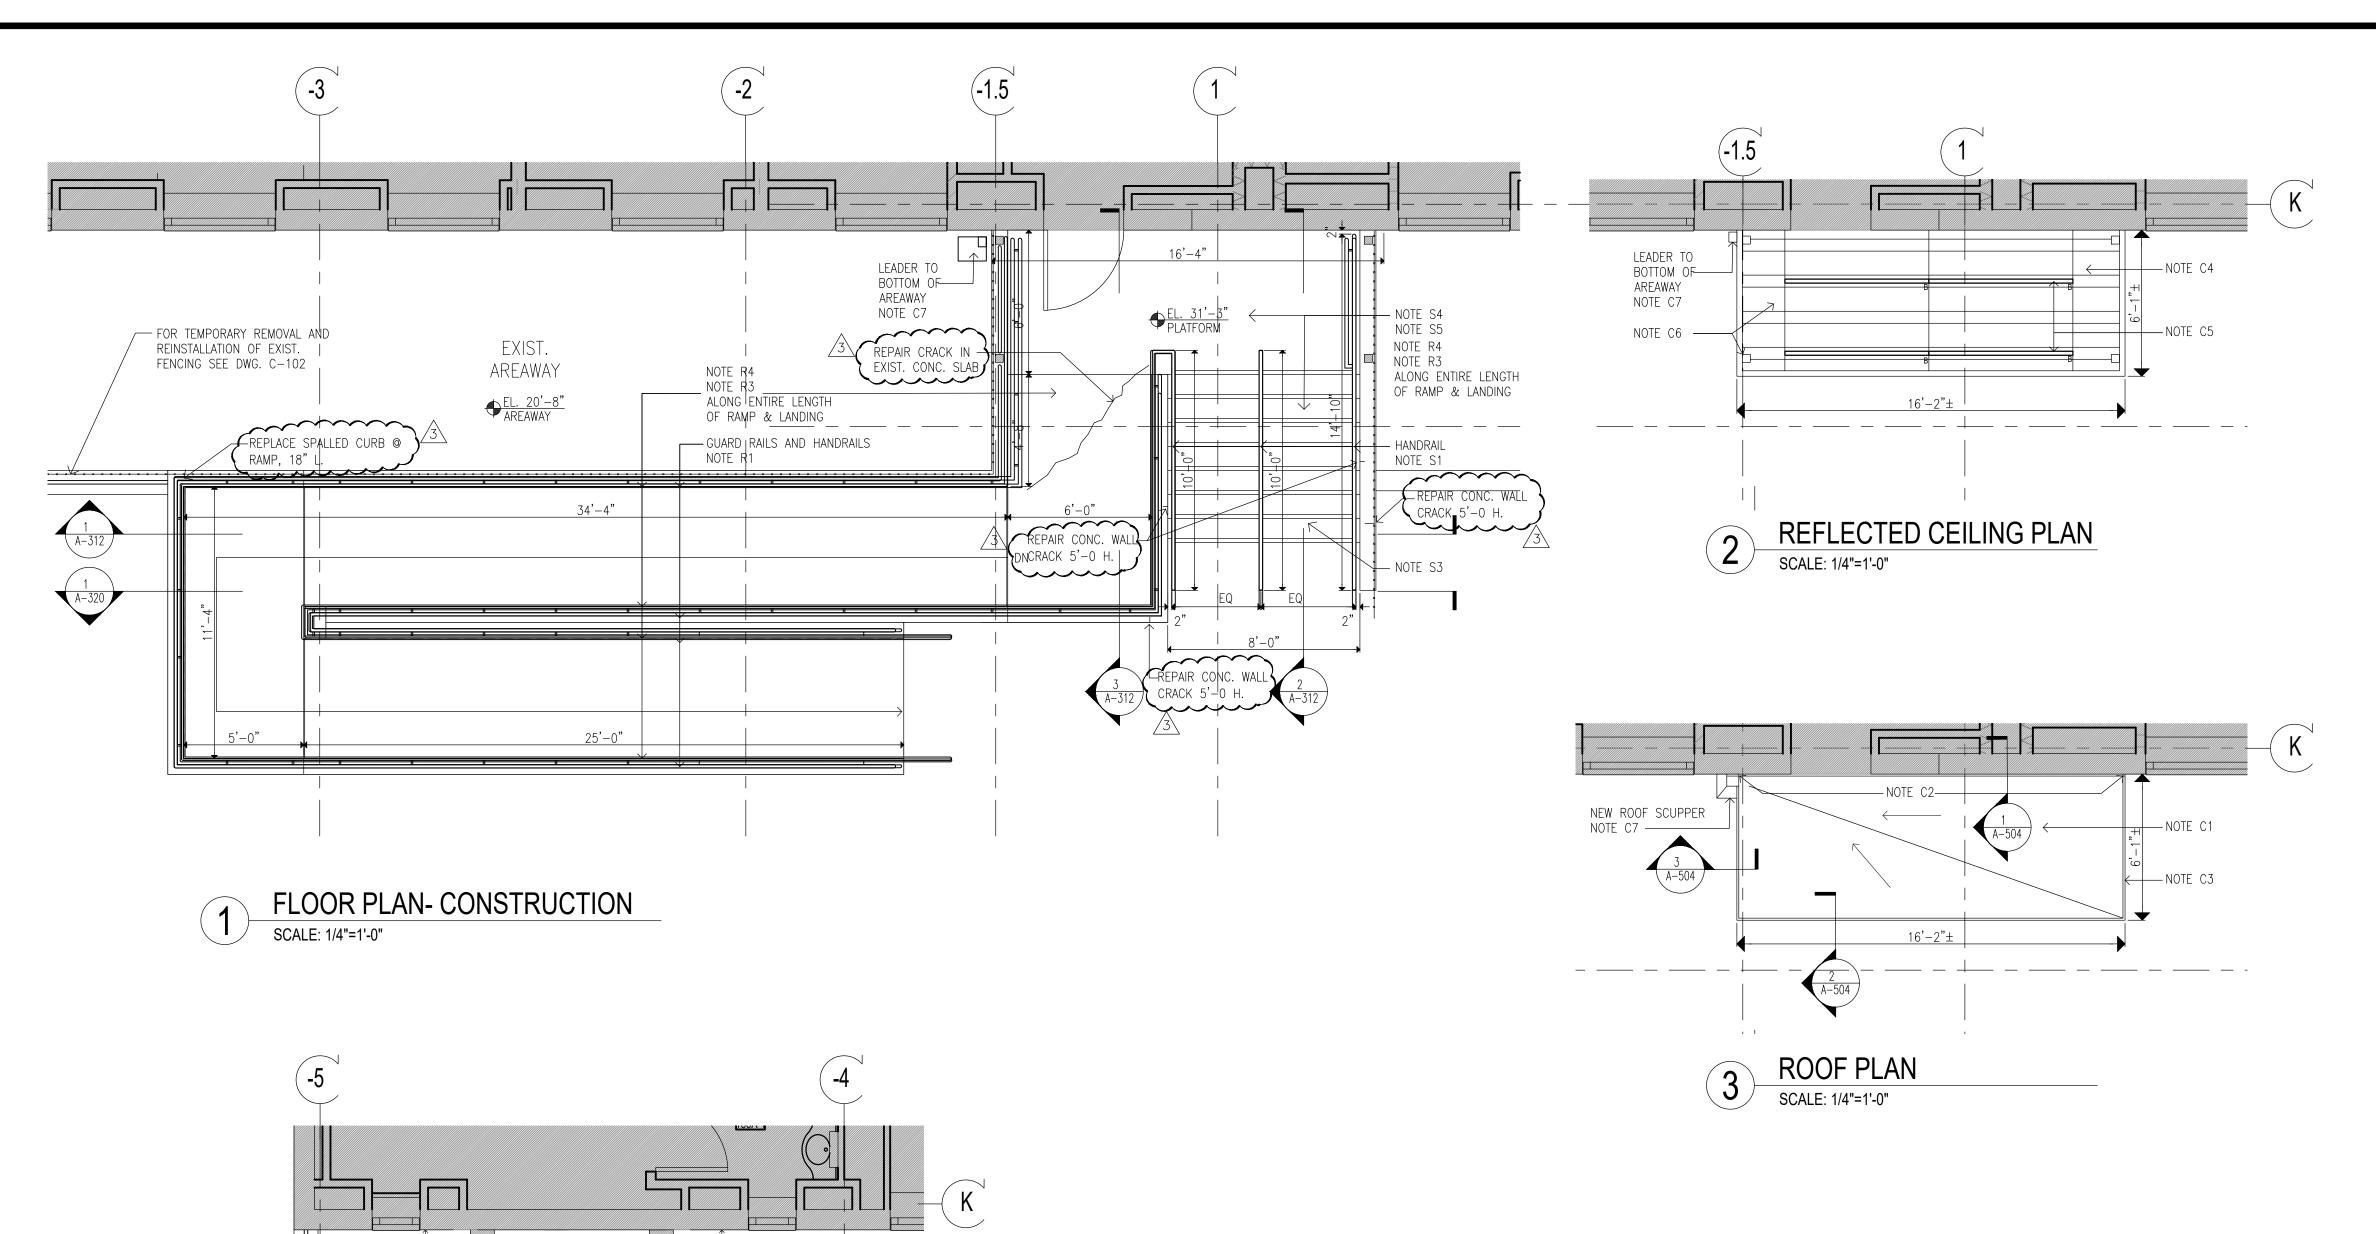

CONSTRUCTION KEYNOTES:

ONLY KEYNOTES CALLED OUT IN THIS DRAWING ARE APPLICABLE

ONLY KEYNOTES CALLED OUT IN THIS DRAW

CANOPY:

MASONRY WALL.

AWAY FROM MASONRY WALL

C1. PROVIDE TWO-LAYER SBS ROOFING SYSTEM OVER ROOF SHEATHING BOARD AND TAPERED INSULATION PITCHED TO ROOF SCUPPERS

C1A. PROVIDE TWO-LAYER SBS ROOFING SYSTEM OVER ROOF SHEATHING BOARD, TAPERED INSULATION PITCHED TO DRAINS, AND PROVIDE R-30 MIN.(@

LOW POINT OF ROOF) RIGID THERMAL INSULATION WITH VAPOR BARRIER.

C2. PROVIDE STAINLESS STEEL BASE FLASHING & STAINLESS STEEL COUNTERFLASHING INSTALLED IN REGLET NOT MORE THAN 1" DEEP INTO ONE HORIZONTAL BRICK COURSE 12" MIN. ABOVE FINISHED SURFACE OF ROOF, SECURE COUNTERFLASHING IN REGLET BRICK COURSE WITH NON—CORRODING METAL WEDGES. COUNTERFLASHING TO BE SET INTO EXISTING REGLET ON

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C5. PROVIDE FLUSH MOUNTED LINEAR LED LIGHT. LIGHT TYPE A: 4'-0 LONG, LIGHT TYPE B: 6'-0 LONG. MANF: FOCAL POINT, SERIES: SEEM 2 (FSM2LWL) (BASIS OF DESIGN)

C6. PROVIDE PAINT TYPE "C" (SEE PROJECT MANUAL) ON ALL CANOPY STEEL STRUCTURAL MEMBERS, INCLUDING EXPOSED STEEL MEMBERS (INCLD POSTS).

COLOR TO BE SELECTED FROM PAINT MANUFACTURER'S STANDARD COLOR.

C7. PROVIDE STAINLESS STEEL ROOF SCUPPER WITH LEADER TO GRADE OR BOTTOM OF AREAWAY TERMINATING IN PRECAST CONCRETE SPLASH BLOCK SET

C8. PROVIDE REINFORCED CONCRETE CANOPY. SEE STRUCTURAL DRAWINGS

CO. FROVIDE REINFORCED CONCRETE CANOFT. SEE STRUCTURAL DRAWING

R1. PROVIDE HOT DIPPED GALVANIZED STEEL GUARDRAIL AND HANDRAIL SYSTEM CORED INTO CURB AT RAMP OR STAIRS UNLESS OTHERWISE SHOWN. 1-1/2" DIA-GUARD RAIL POST, TOP & BOTTOM RAIL, 5/8" DIA. INTERMEDIATE STEEL BARS & 1-1/2" DIA. HAND RAIL

R2. ALLOW 21 DAYS MIN FOR CONCRETE REPAIRS IN TO FULLY CURE PRIOR TO APPLICATION OF RESURFACING COATING. APPLY TREMCO "VULKEM EWS SYSTEM" OVER EXPOSED CONCRETE SURFACES OF EXISTING AND NEW STAIRS, PLATFORMS, AND RAMP WALKING SURFACES (INCLUDING CURBS AND WALLS).

R3. PROVIDE SEALANT AS PER PROJECT MANUAL SECTION 079200 2.01.3(A), BACKER ROD & FILLER MATERIAL AT EDGES OF STAIR TREADS/RISERS & CURB/BUILDING WALL.

R4. PROVIDE REINFORCED CONCRETE RAMP SLAB/DECK. SEE STRUCTURAL

R4. PROVIDE REINFORCED CONCRETE RAMP SLAB/DECK. SEE STRUCTUR
DRAWINGS

STAIR:


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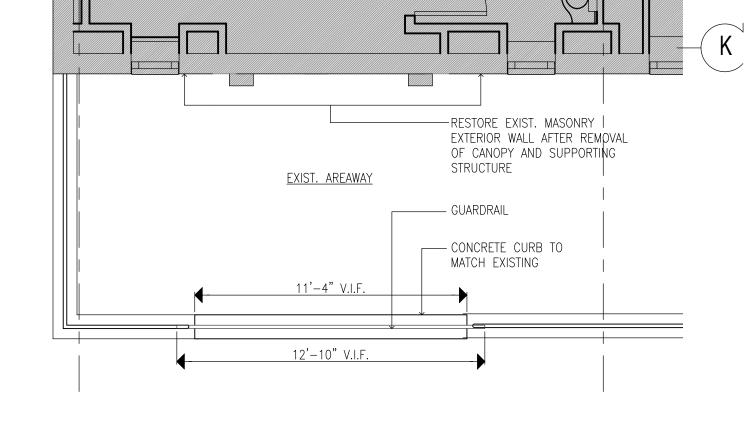
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CONSTRUCTION PLAN


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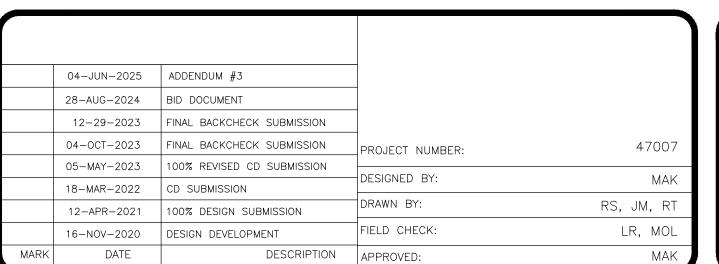
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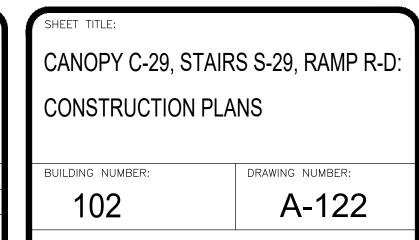
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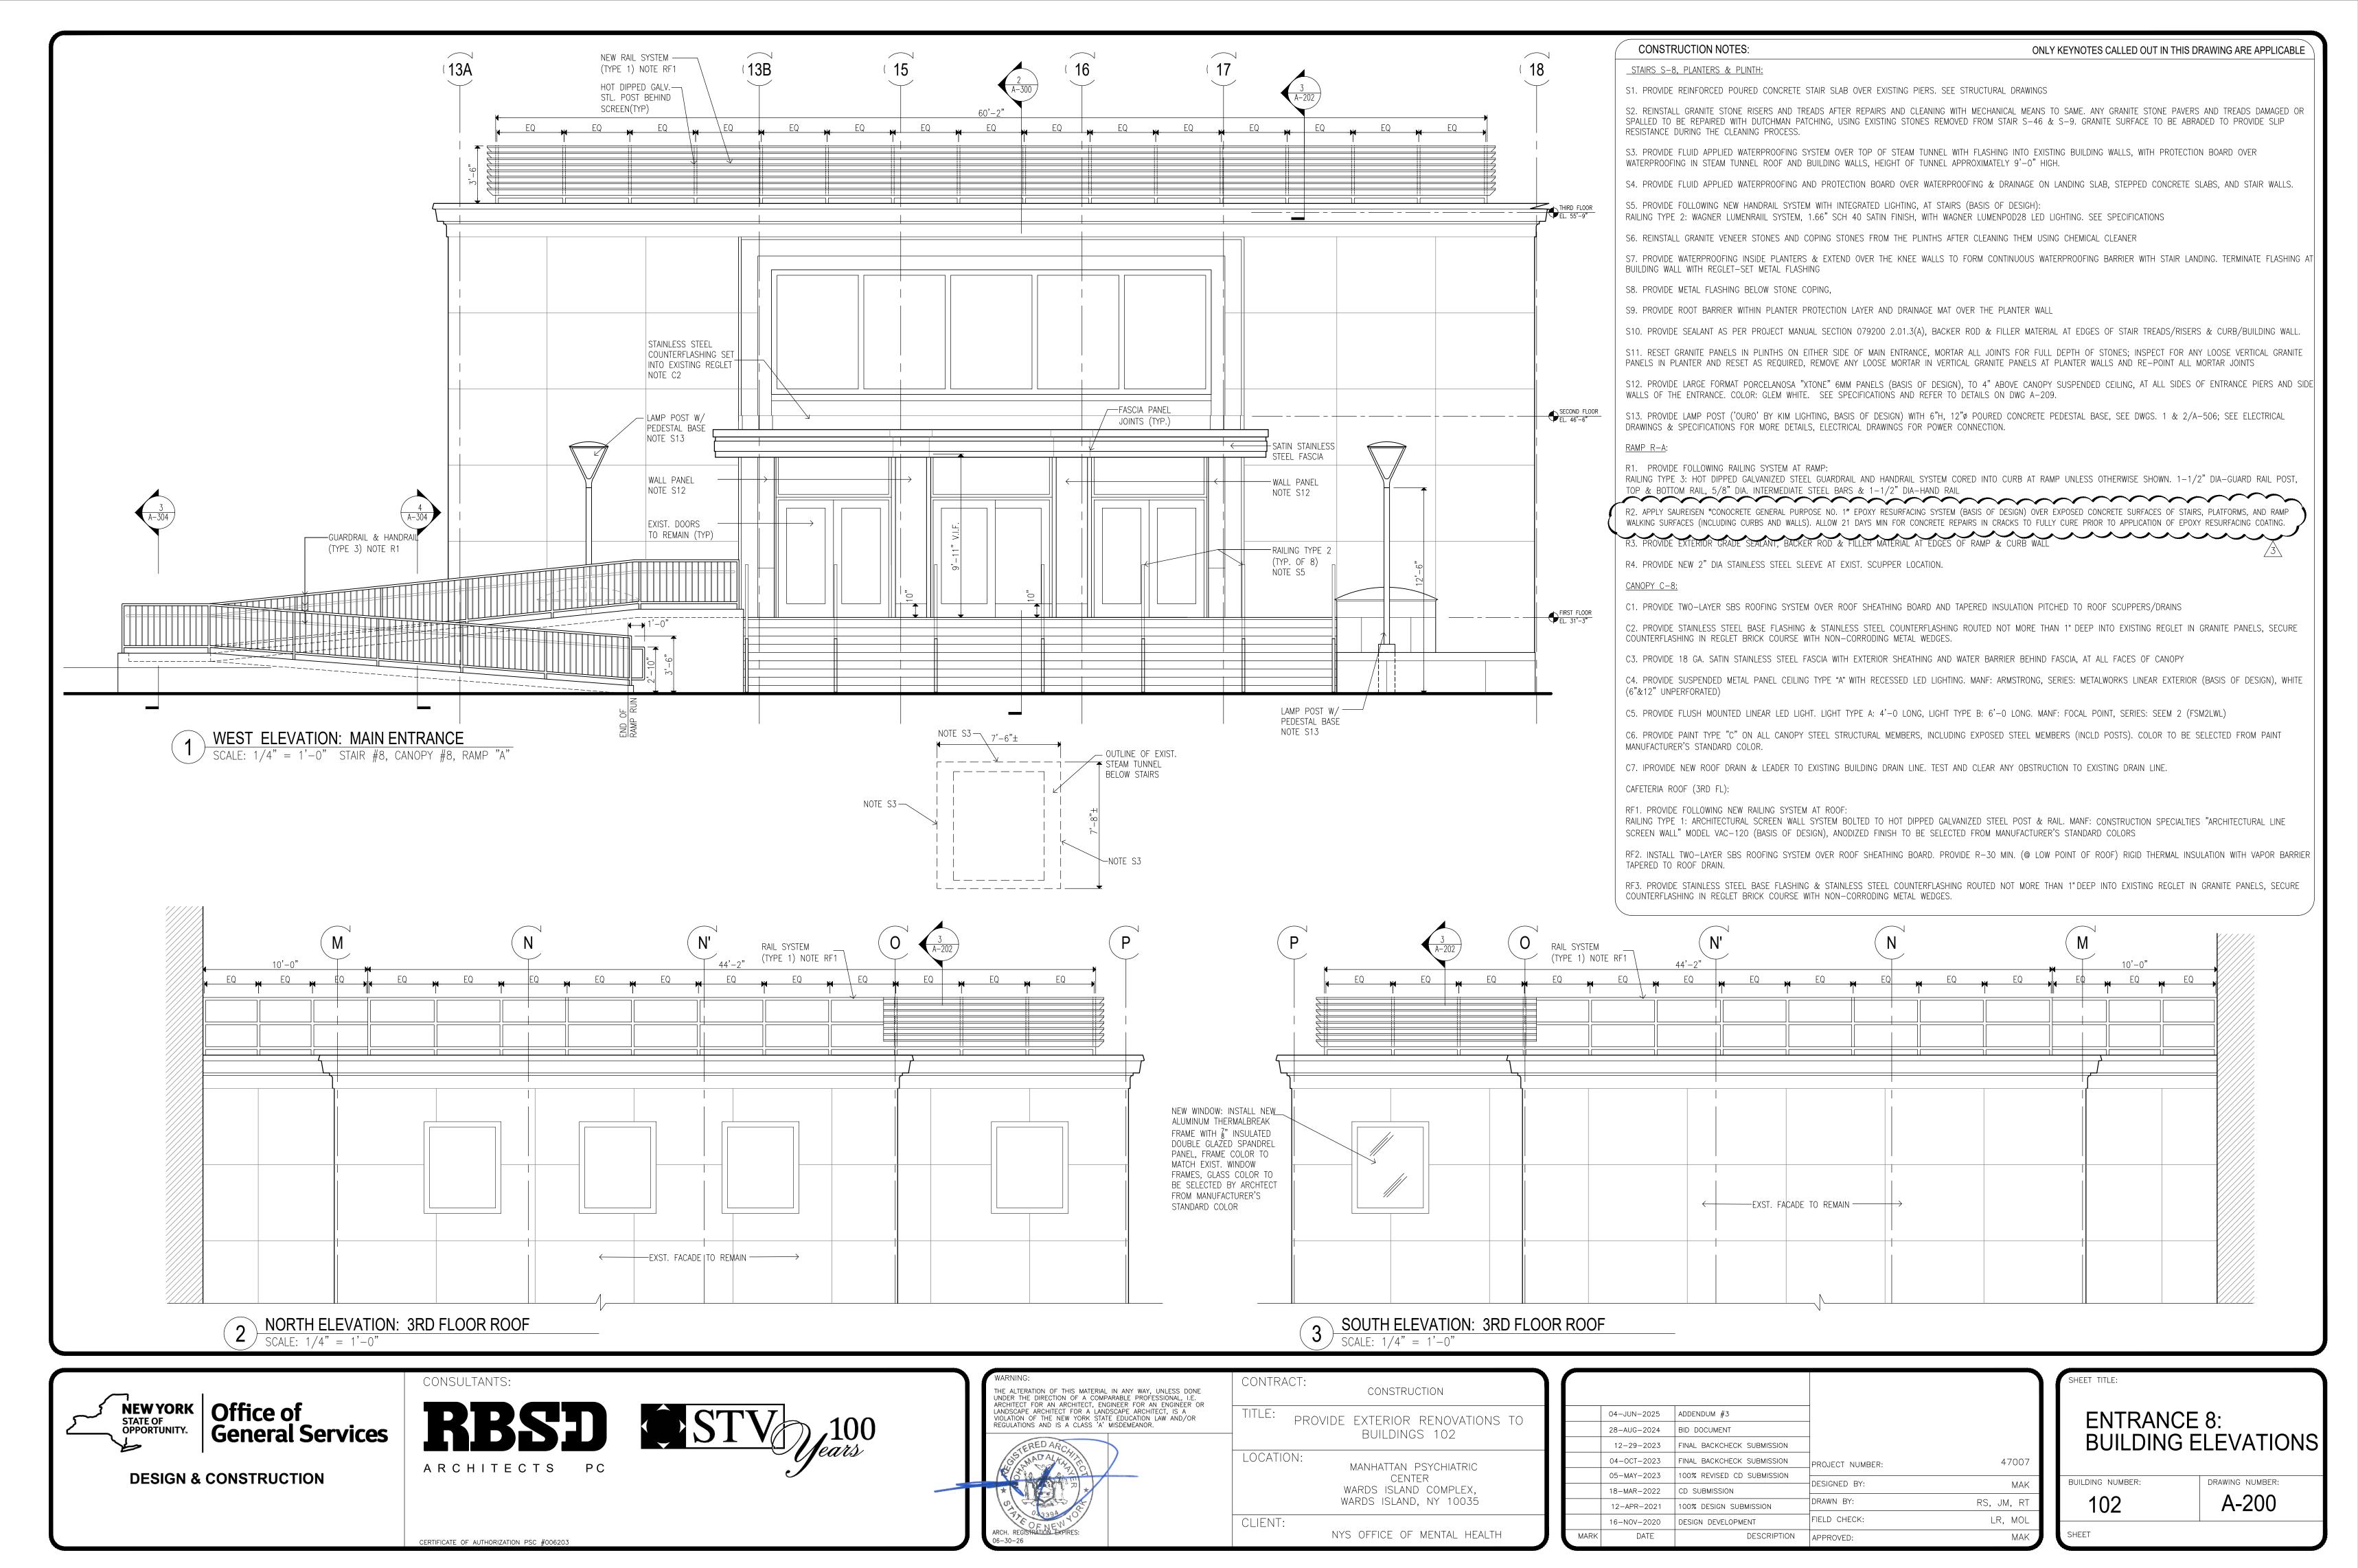
NEW YORK
STATE OF
OPPORTUNITY.
General Services

**DESIGN & CONSTRUCTION** 






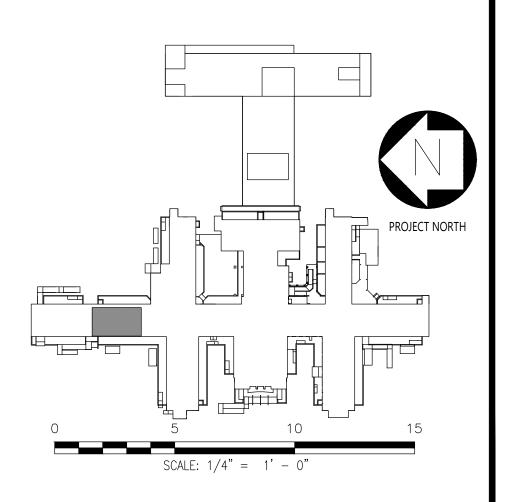

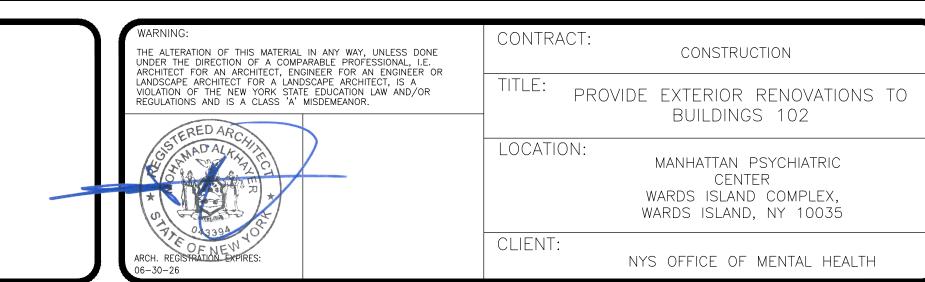

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NYS OFFICE OF MENTAL HEALTH
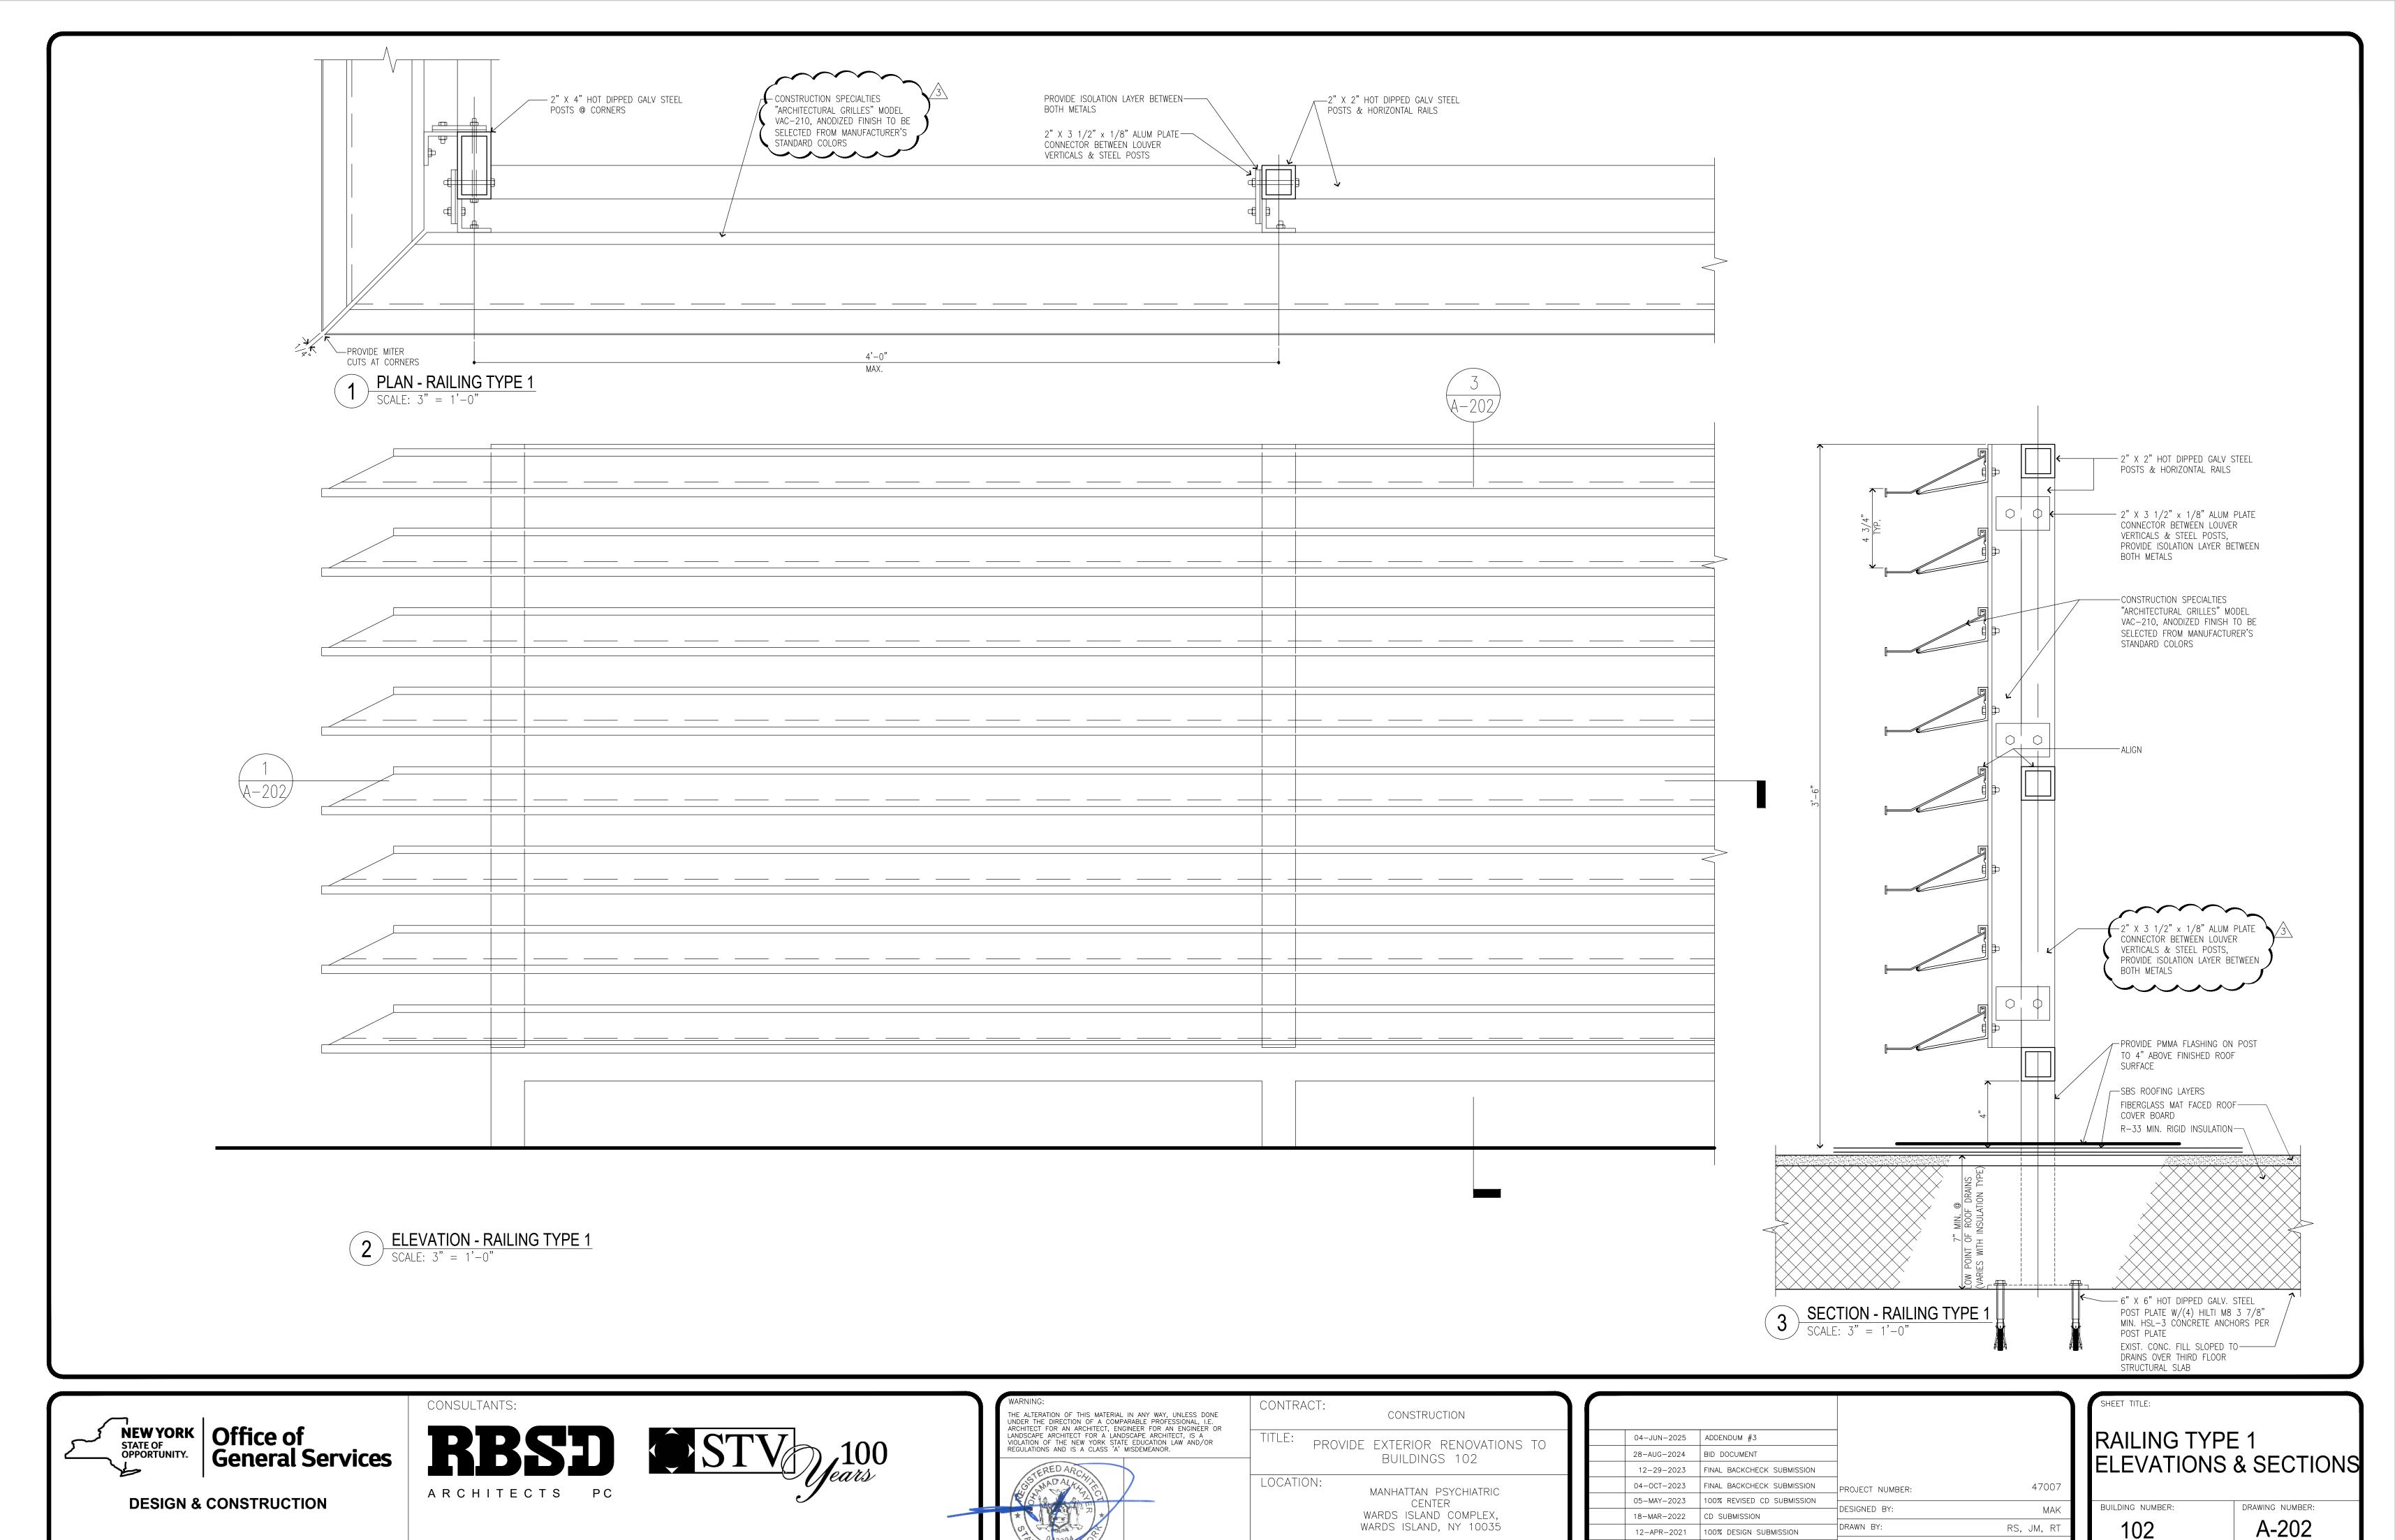
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16-NOV-2020


DATE

DESIGN DEVELOPMENT

LR, MOL

MAK

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NYS OFFICE OF MENTAL HEALTH
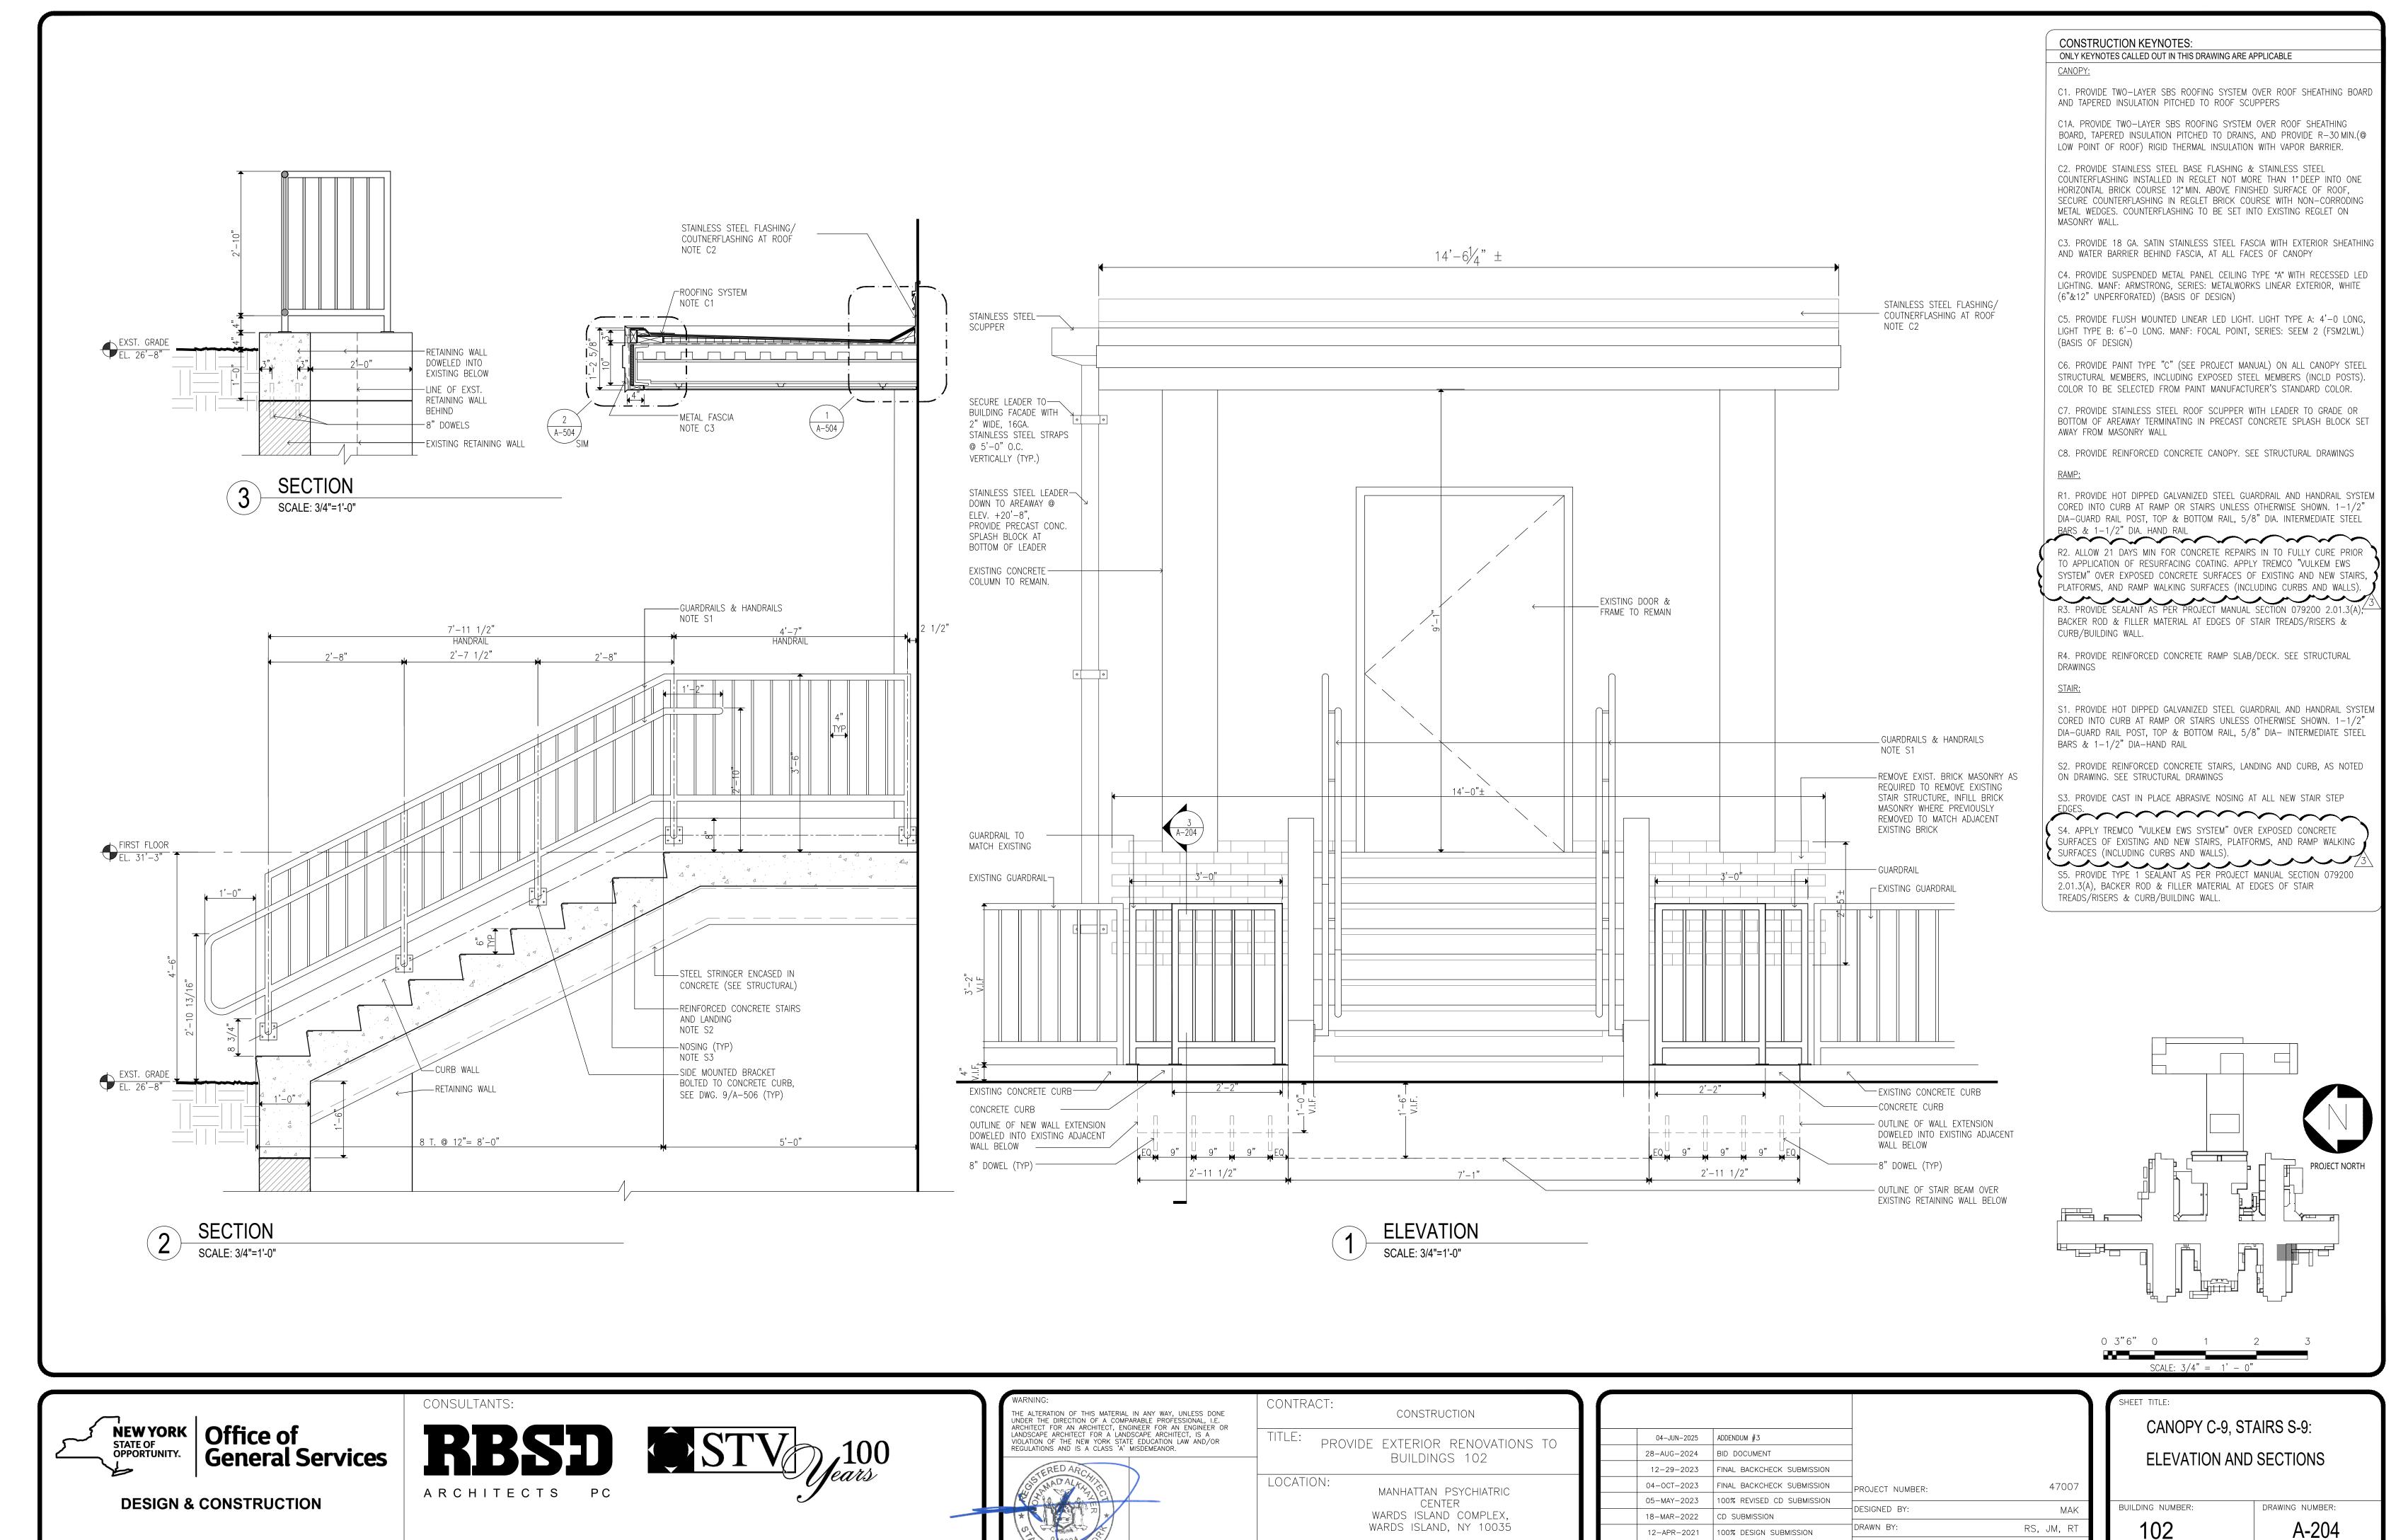
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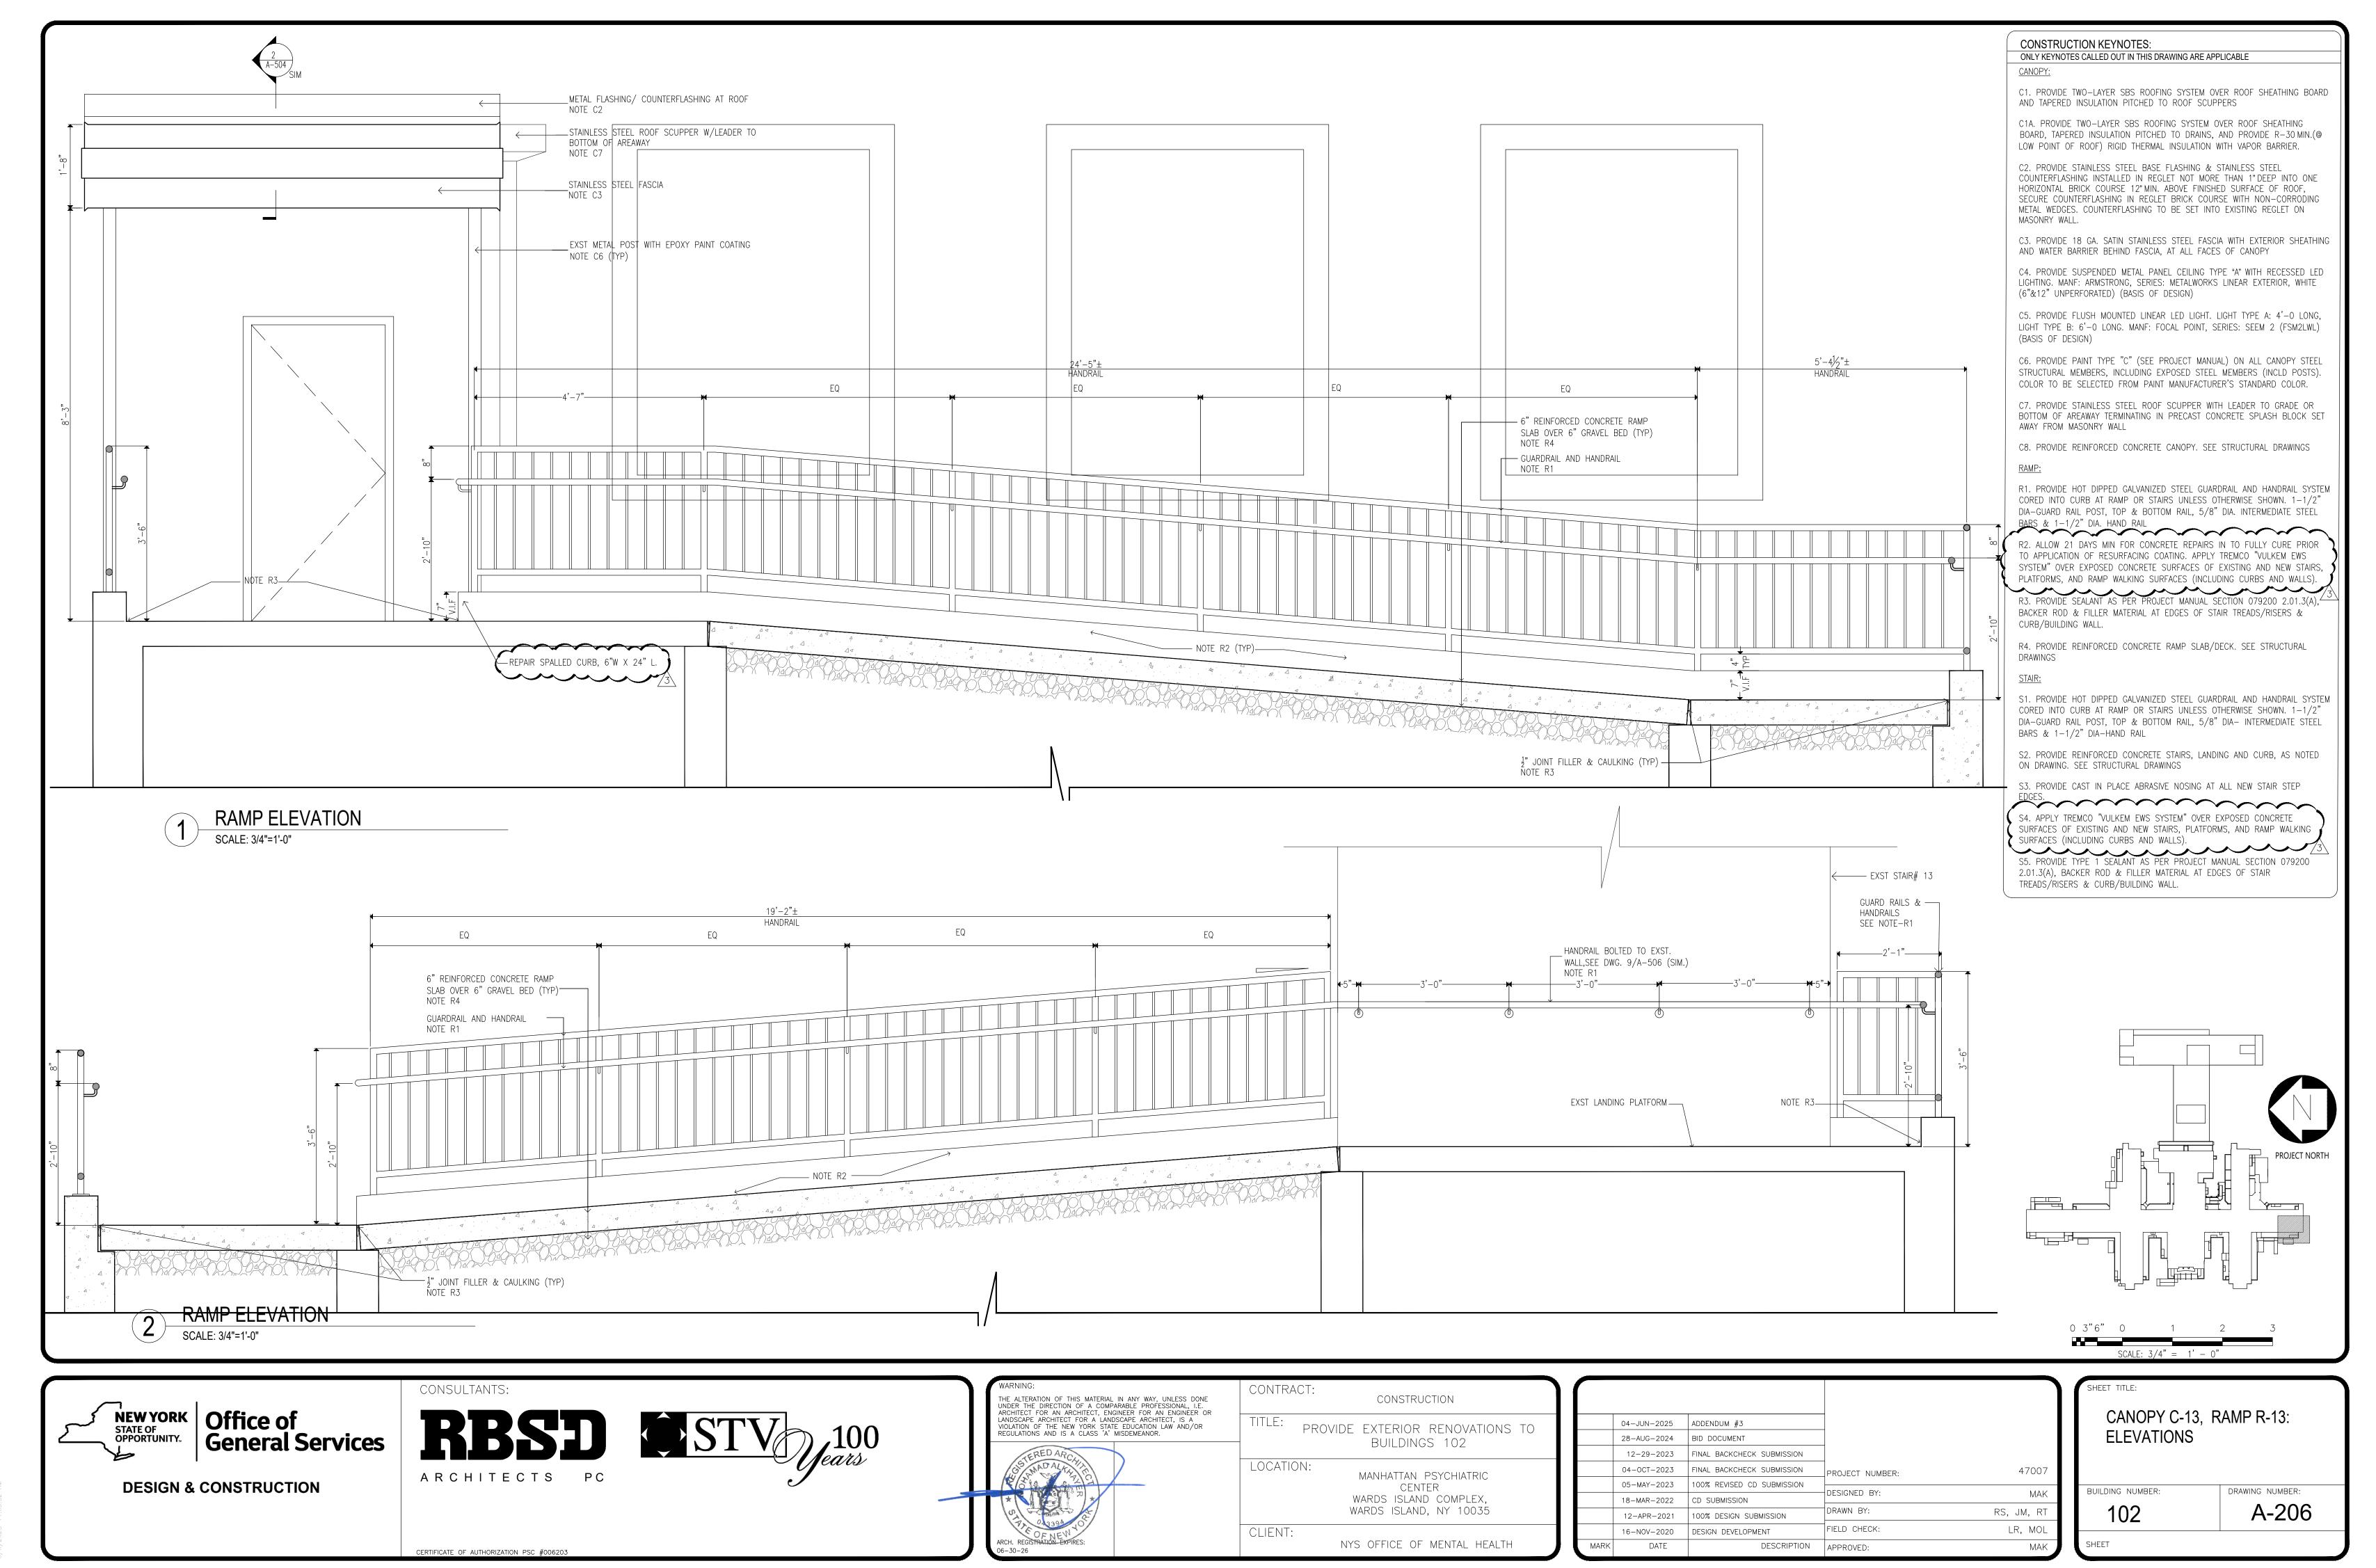
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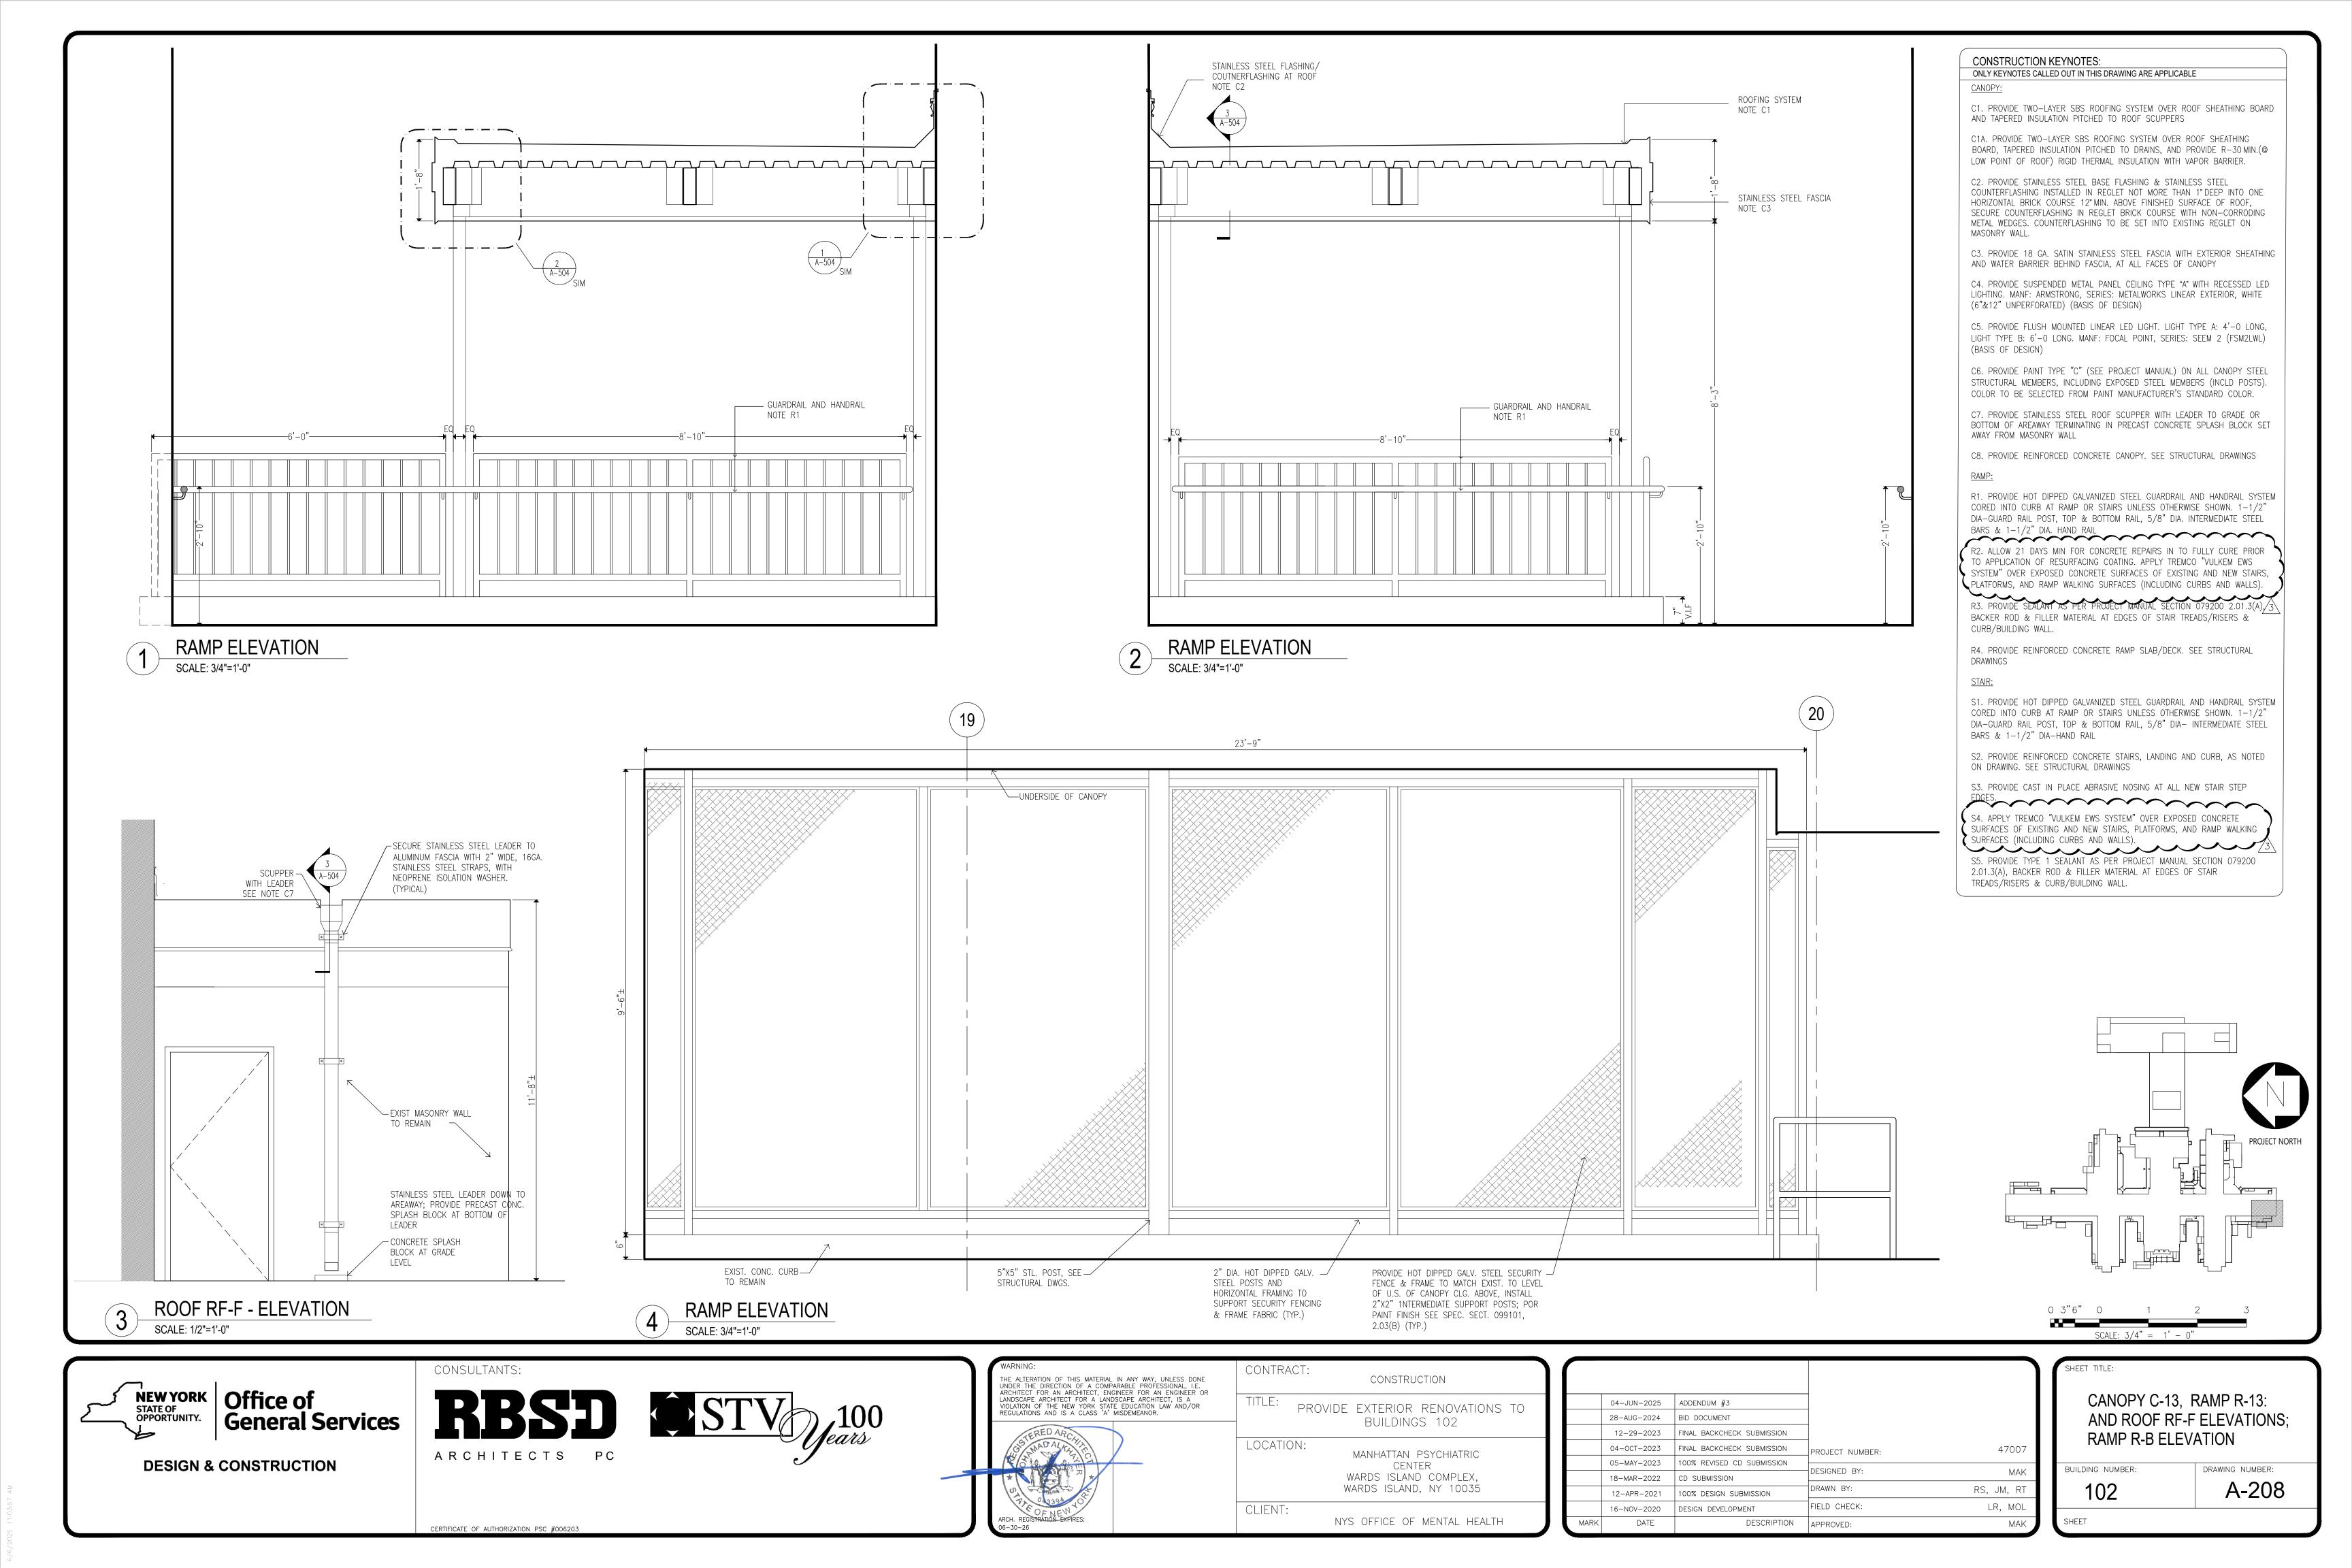
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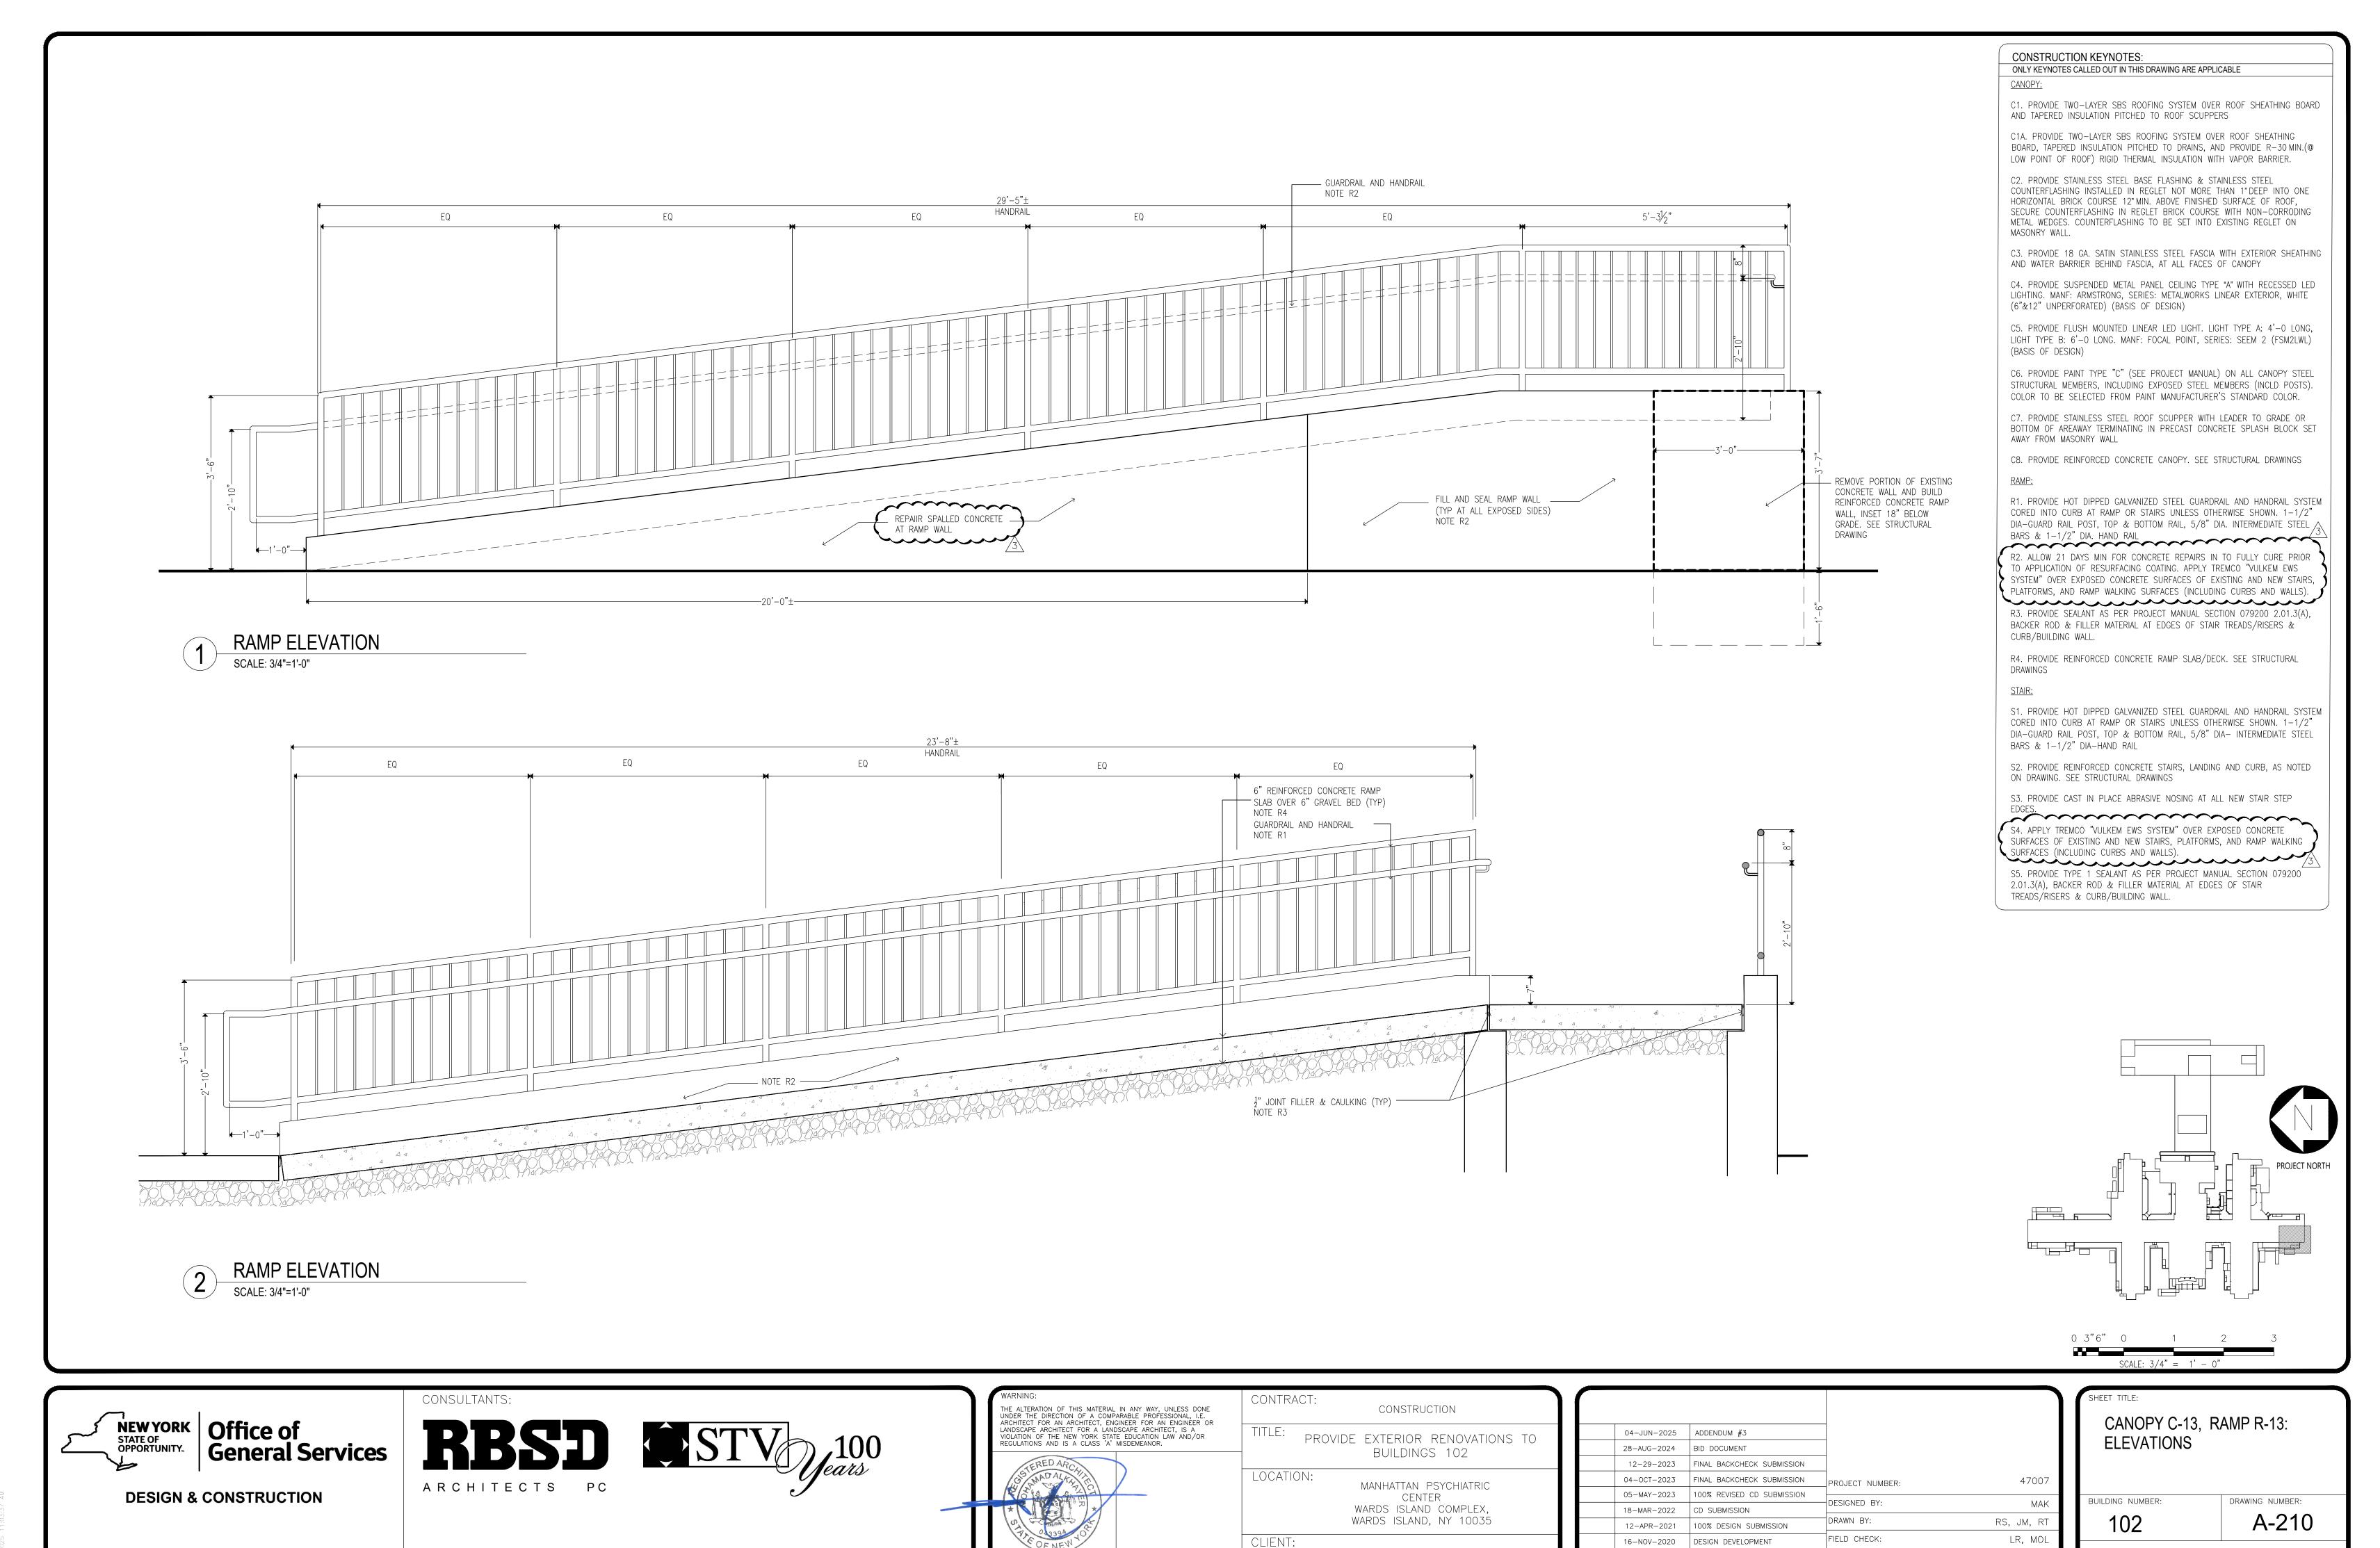
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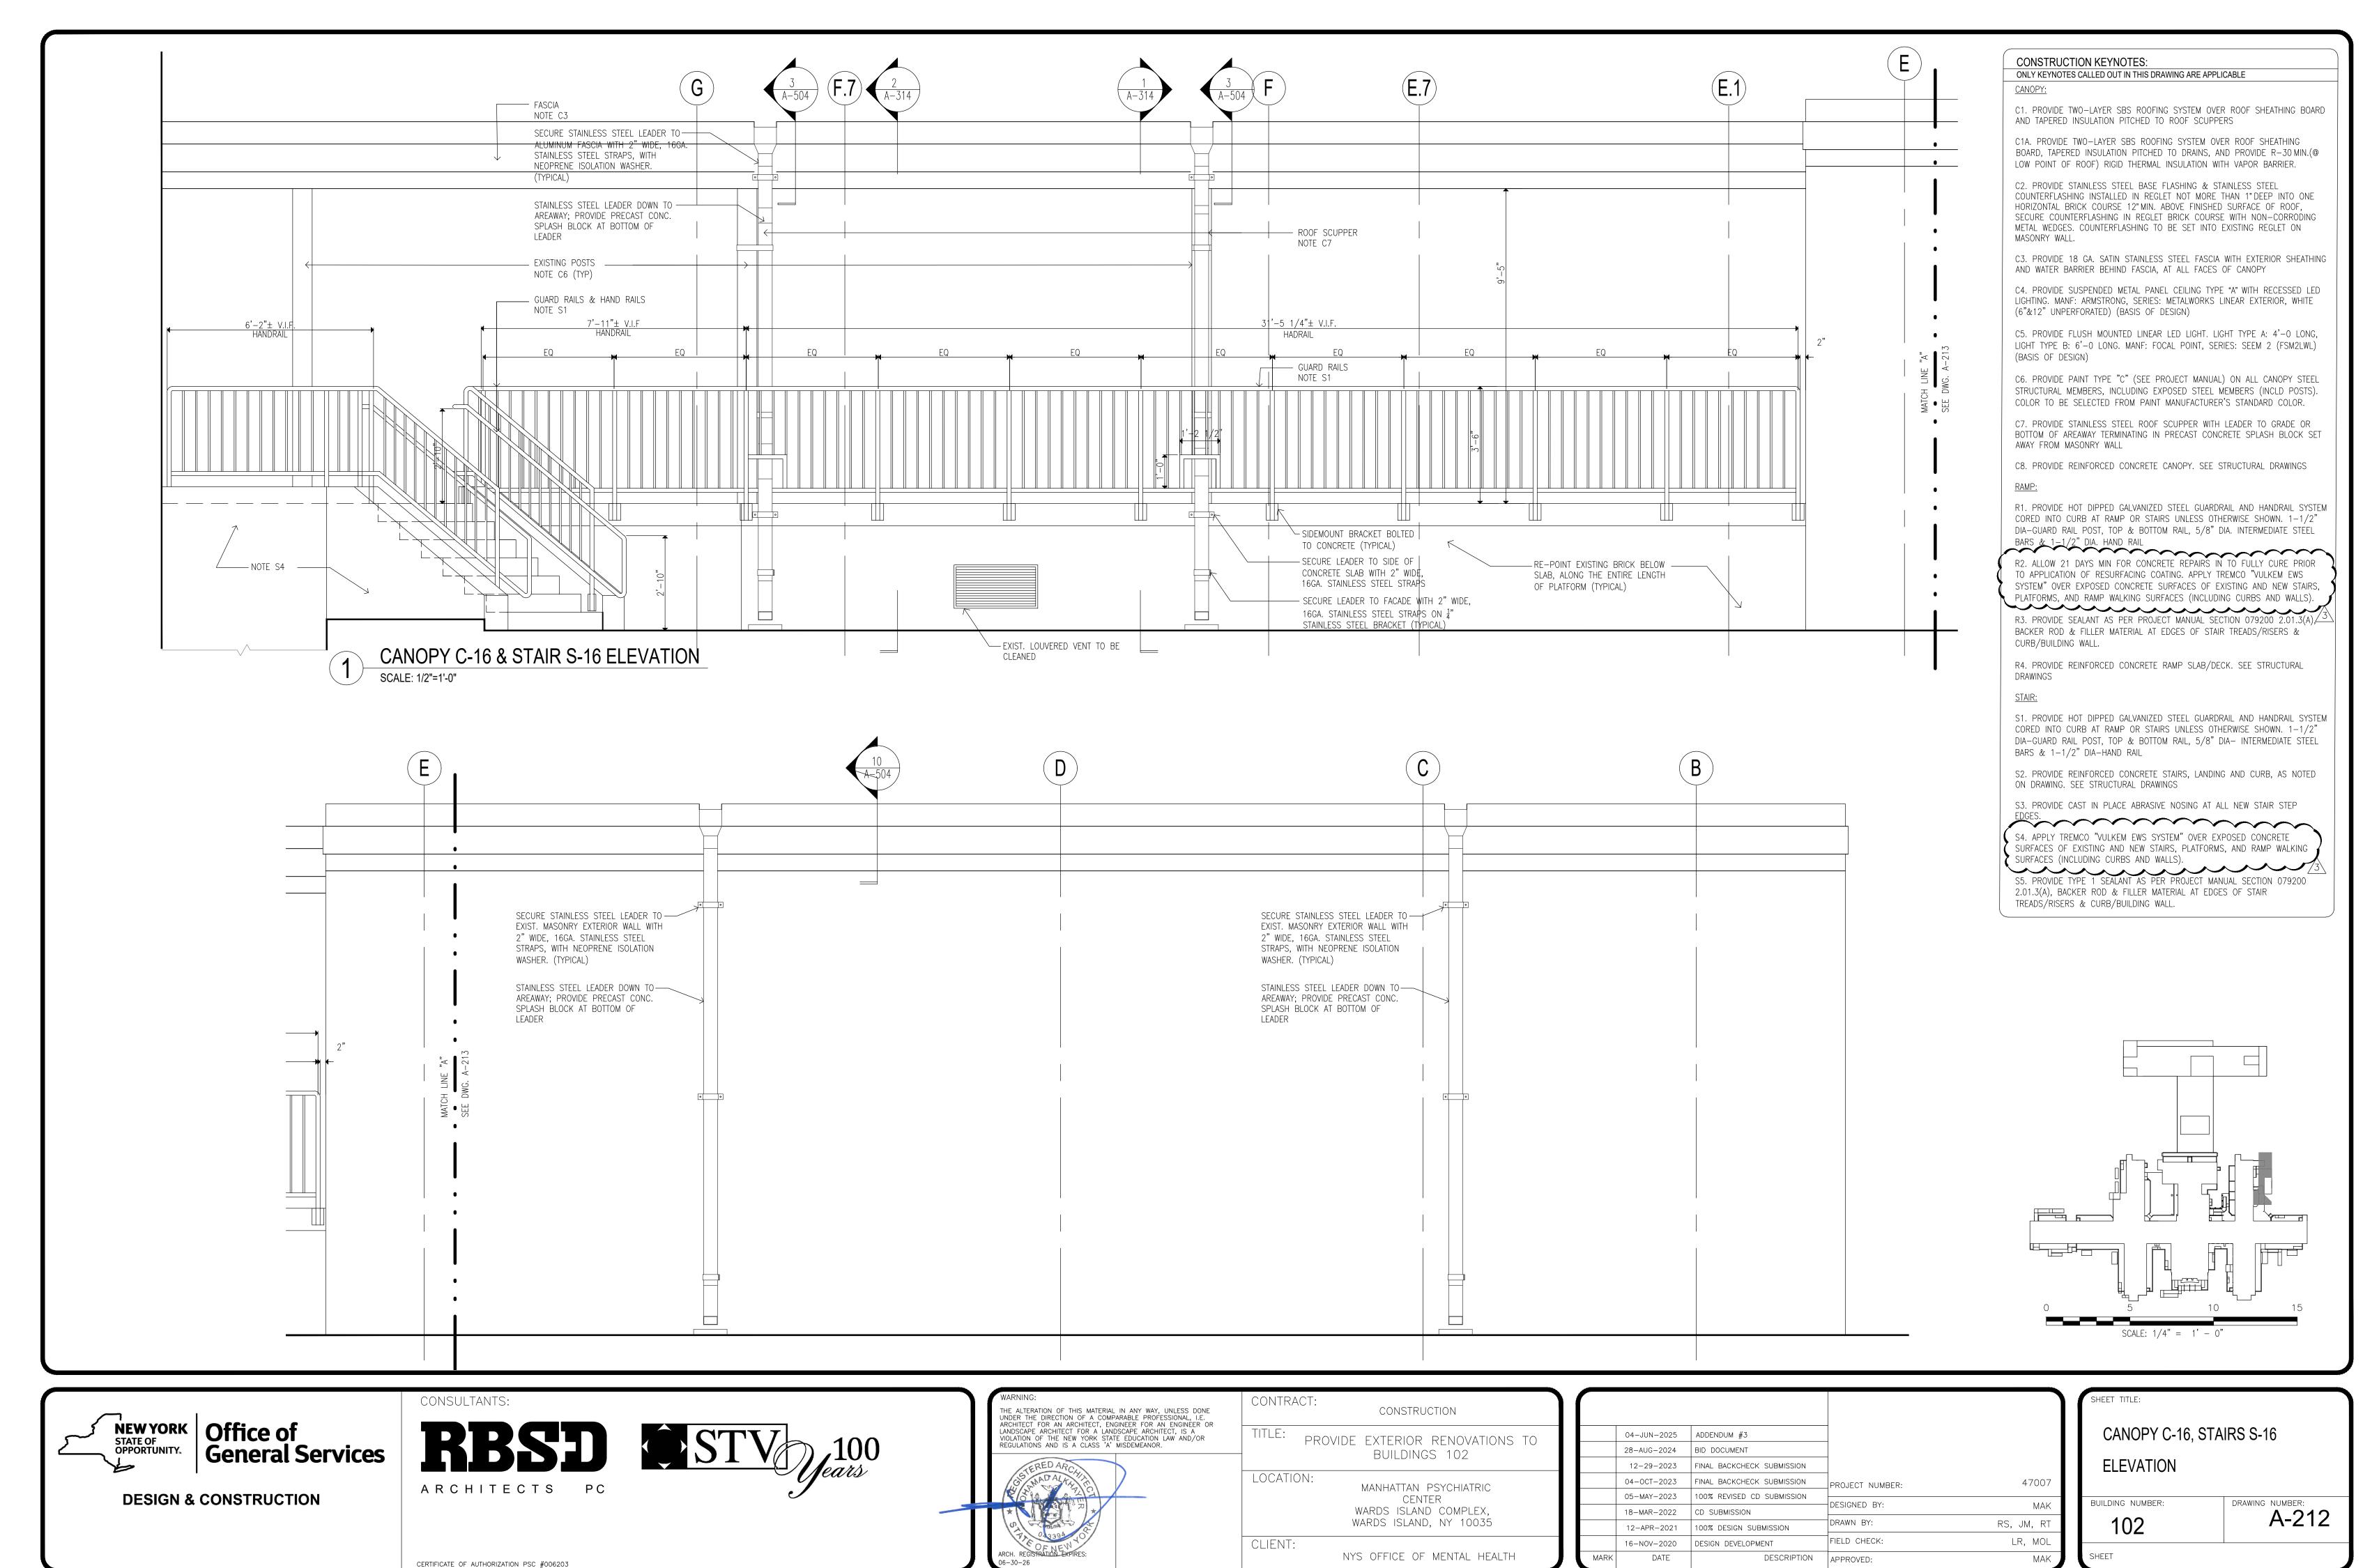





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MAK



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NYS OFFICE OF MENTAL HEALTH

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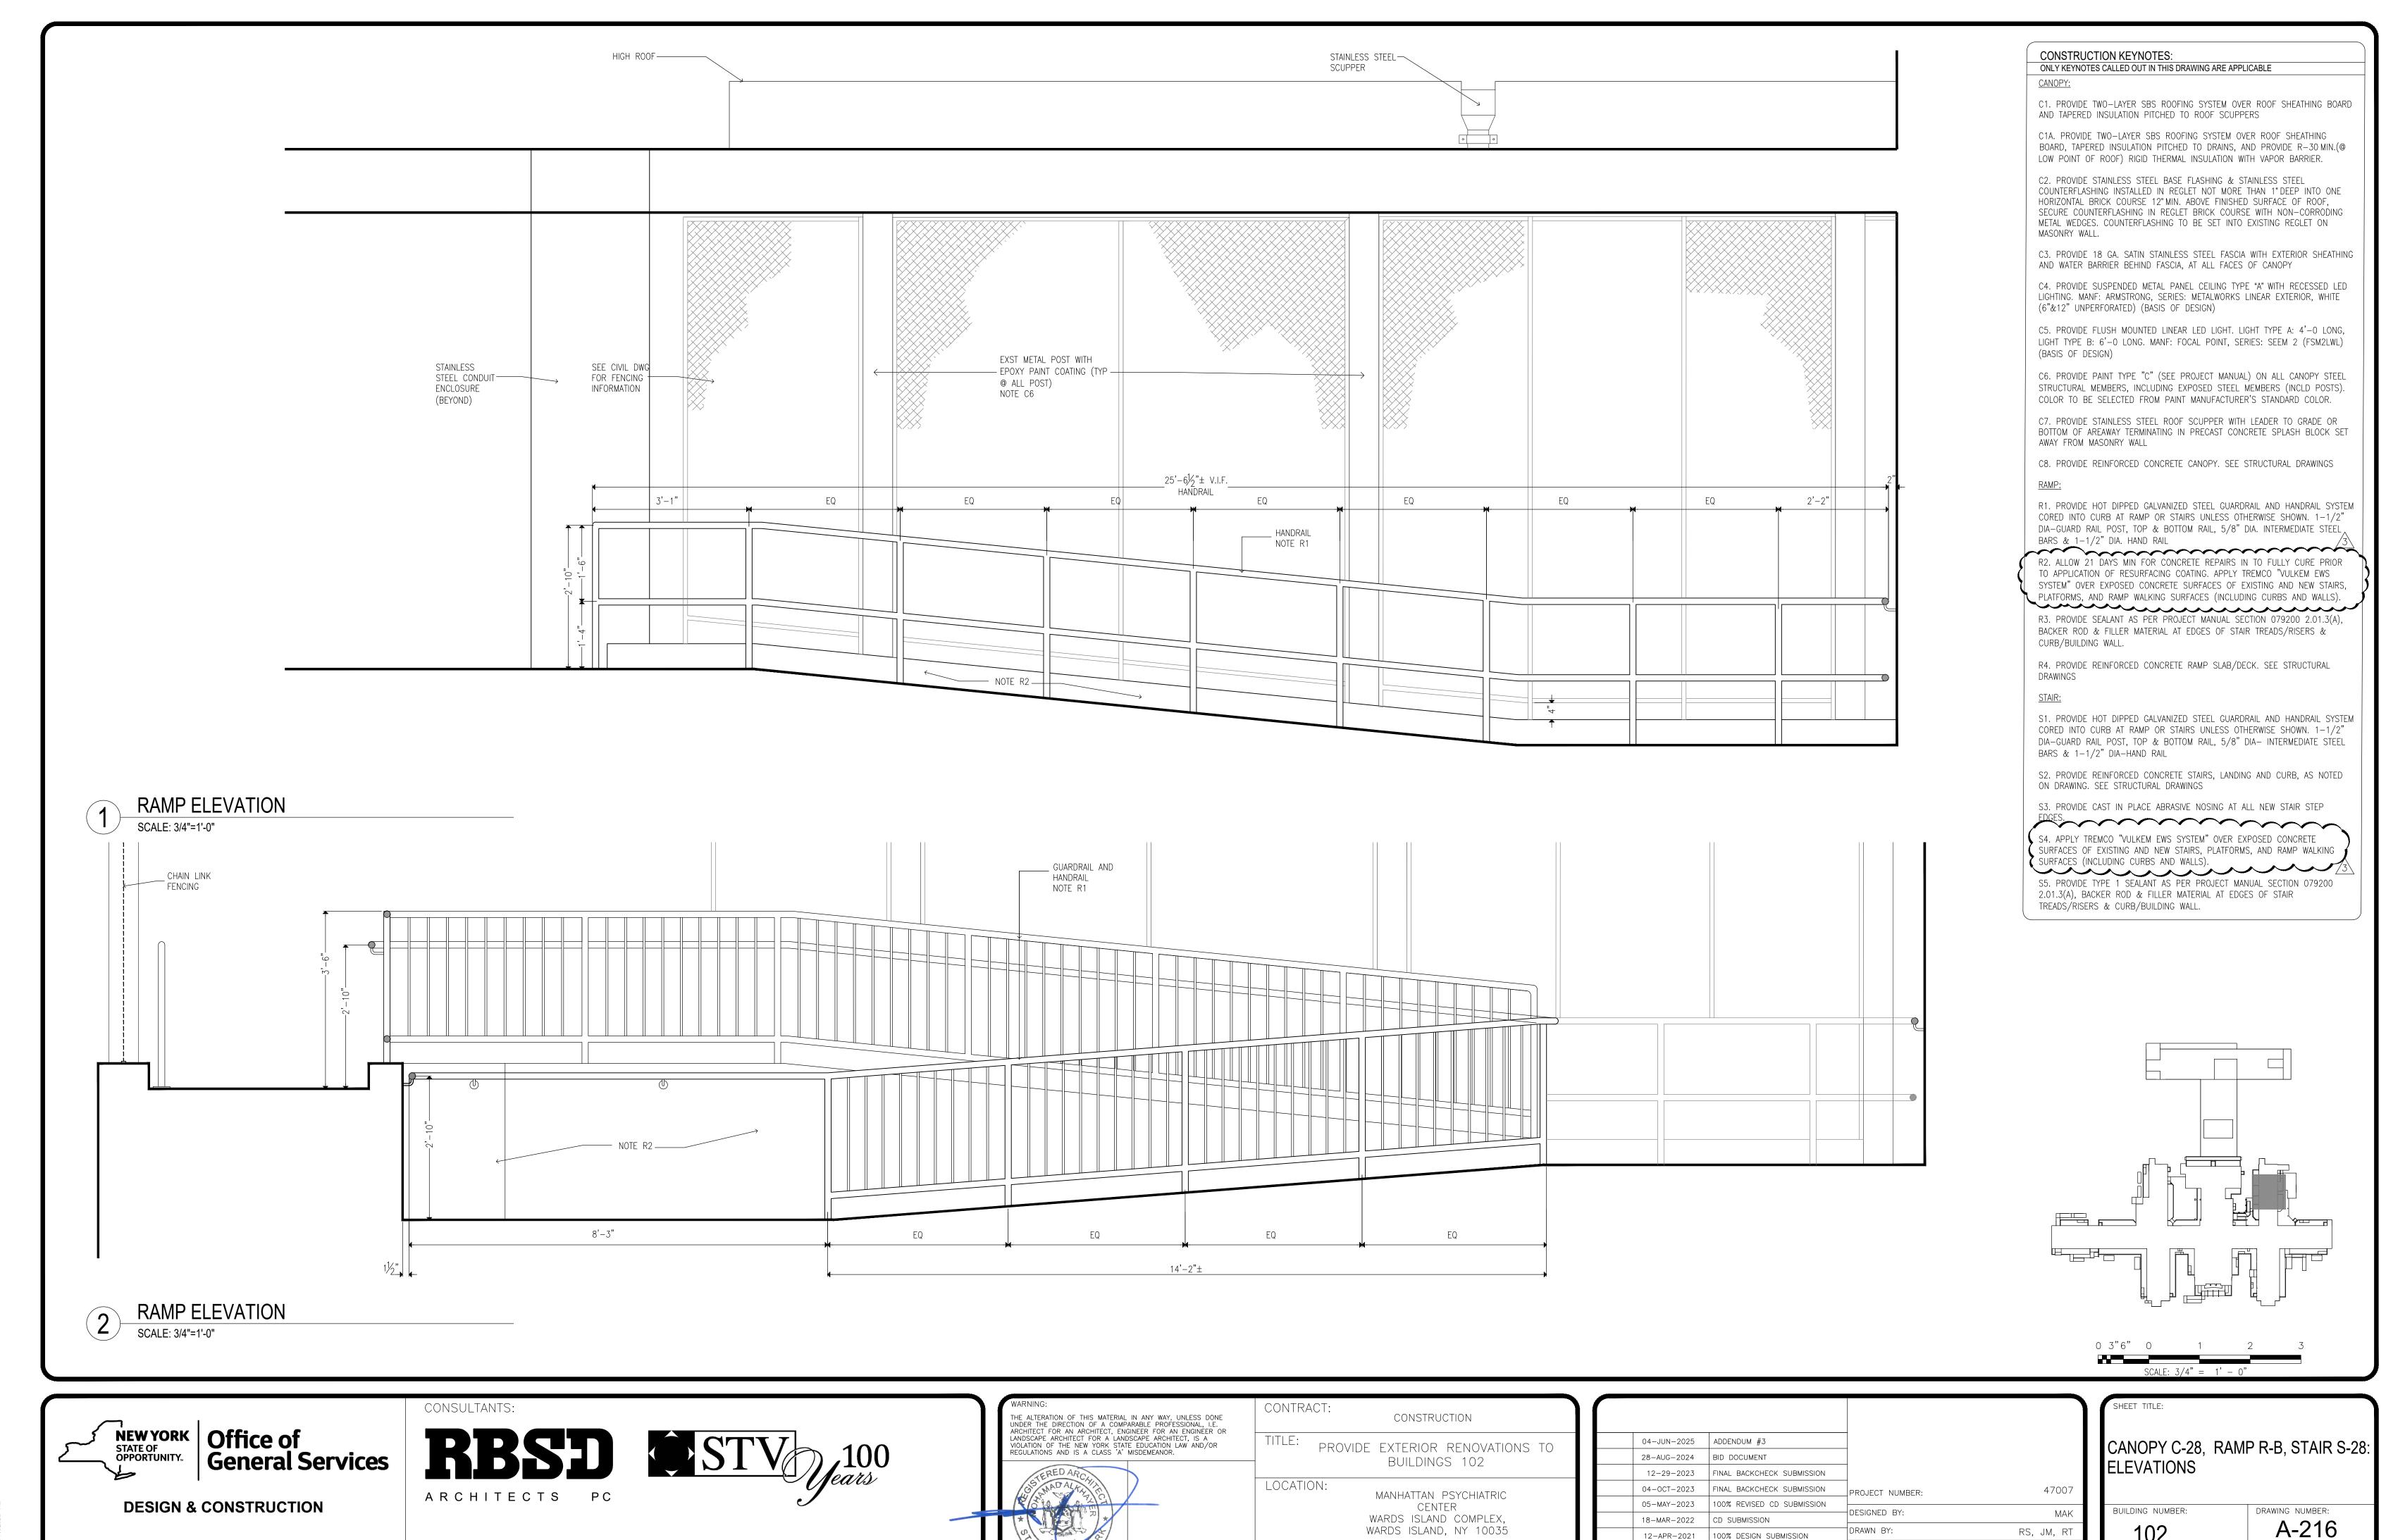
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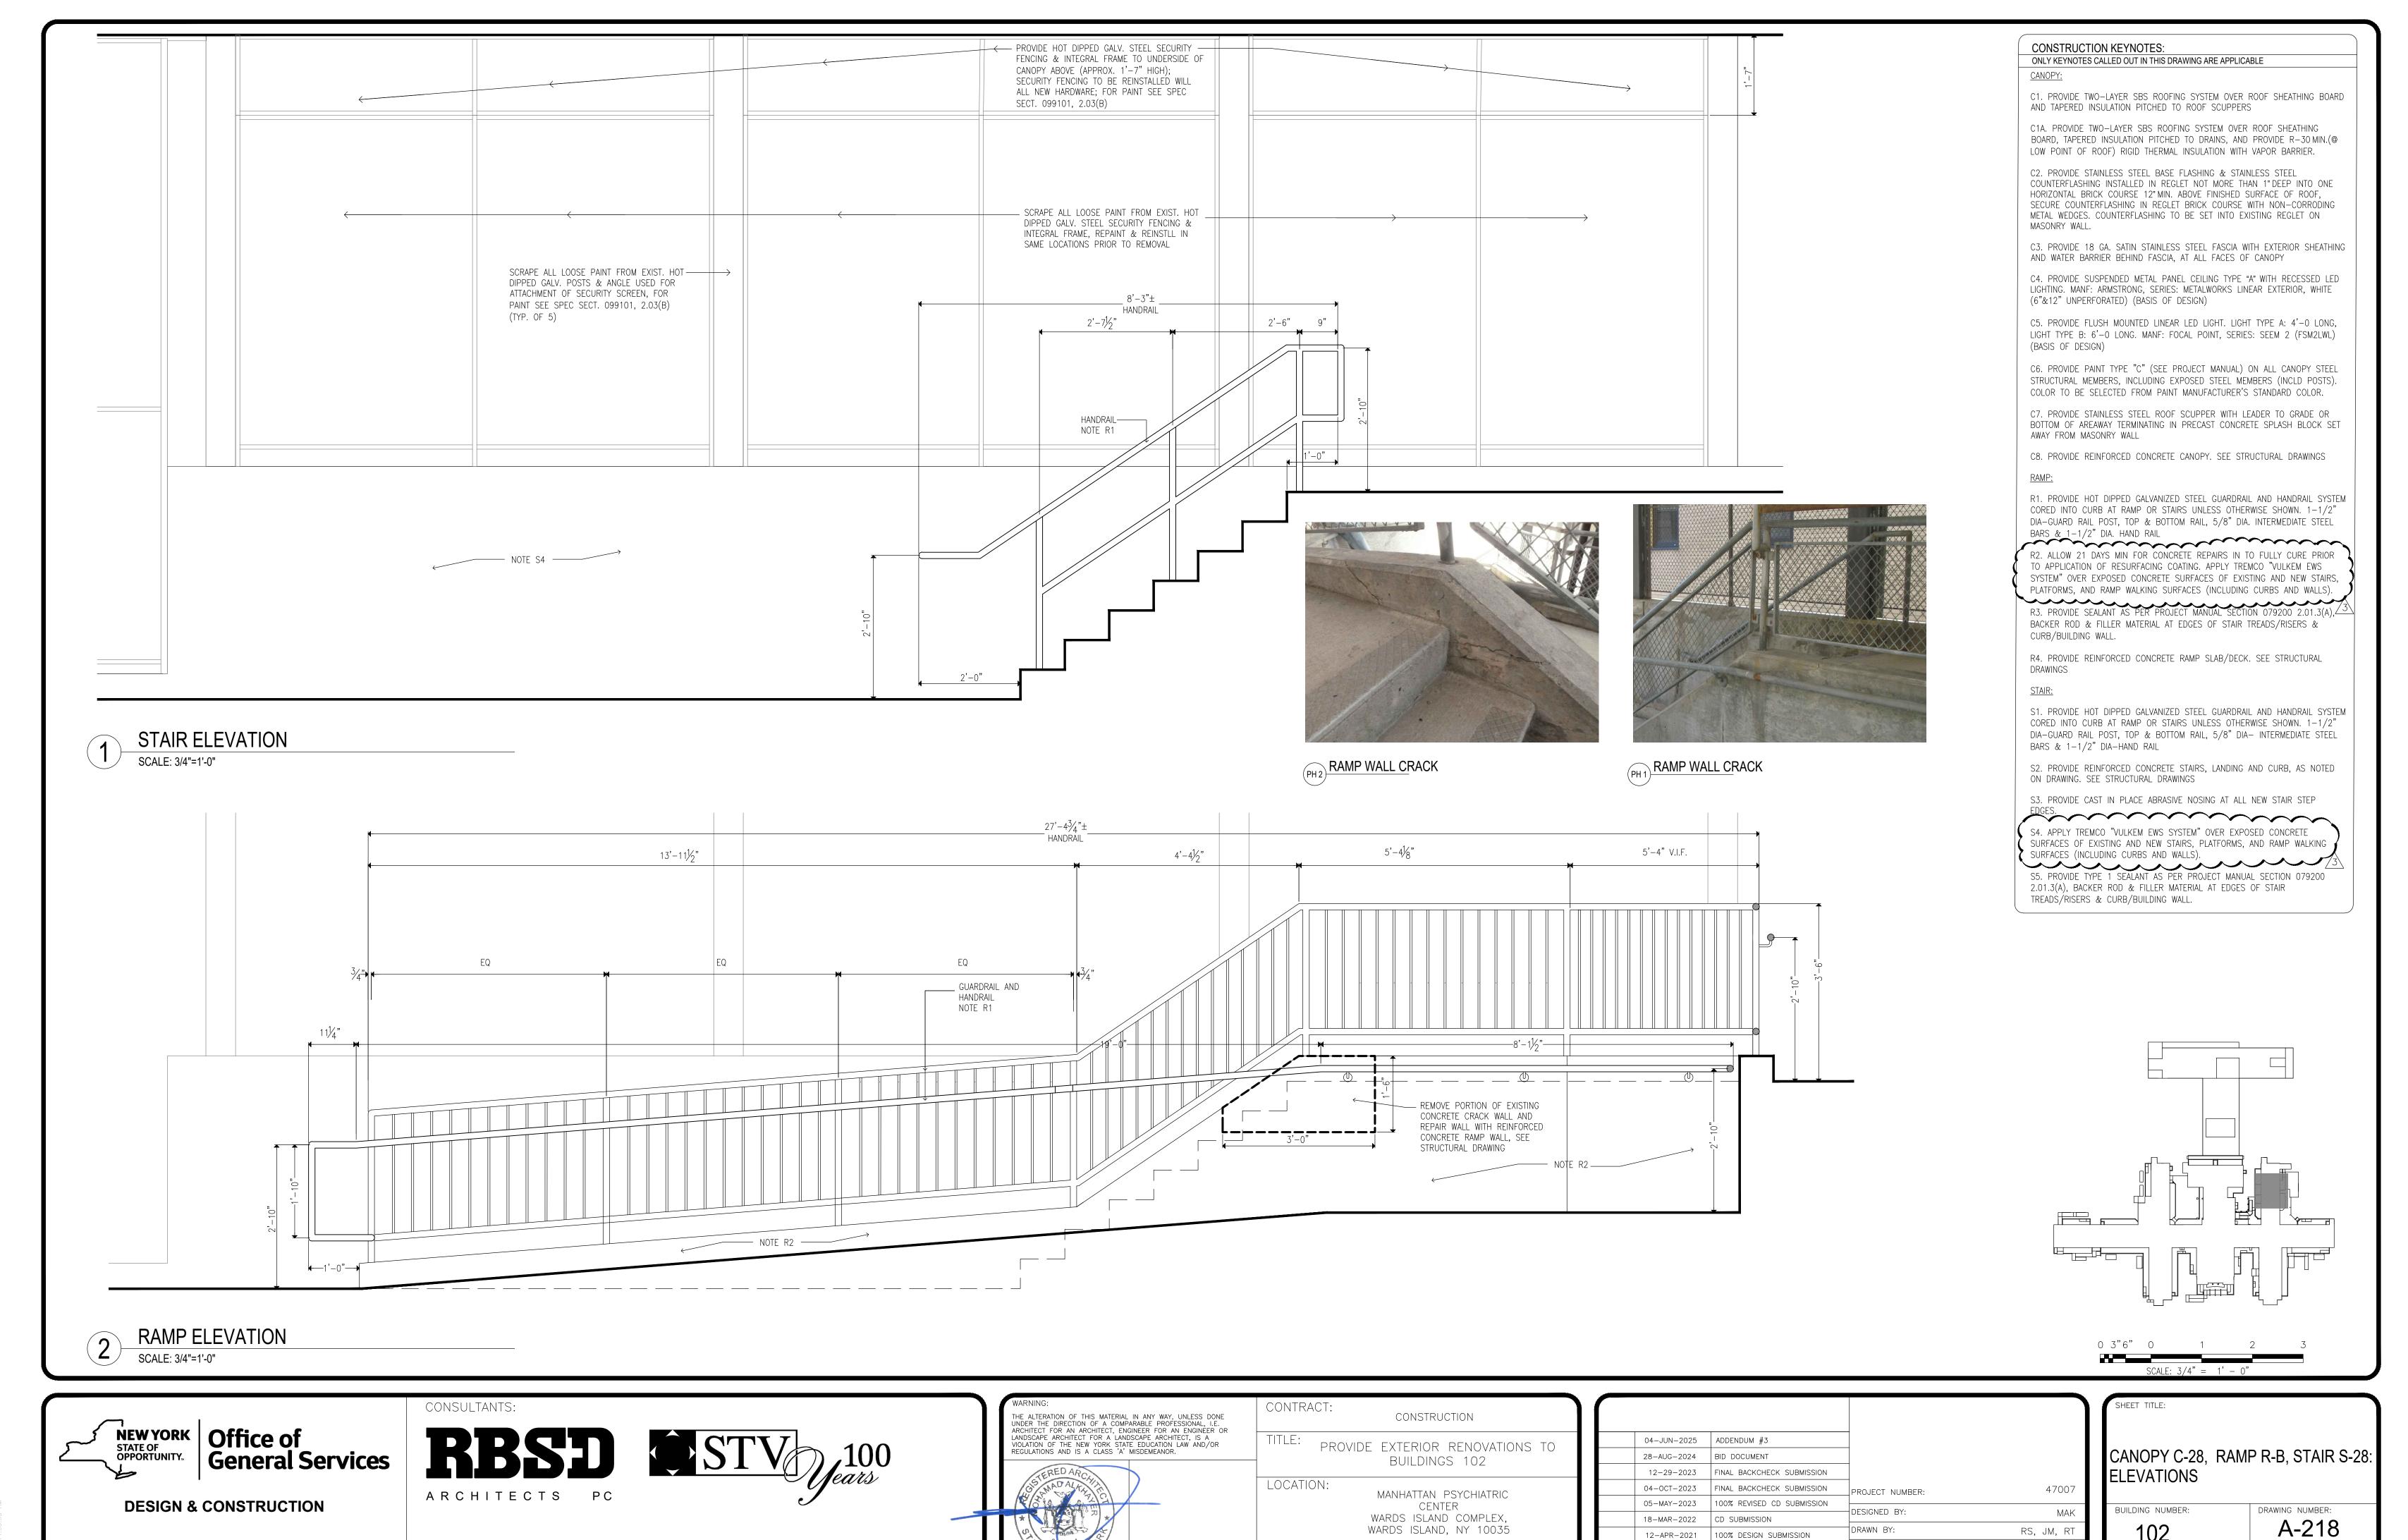
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DESIGN DEVELOPMENT

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MAK
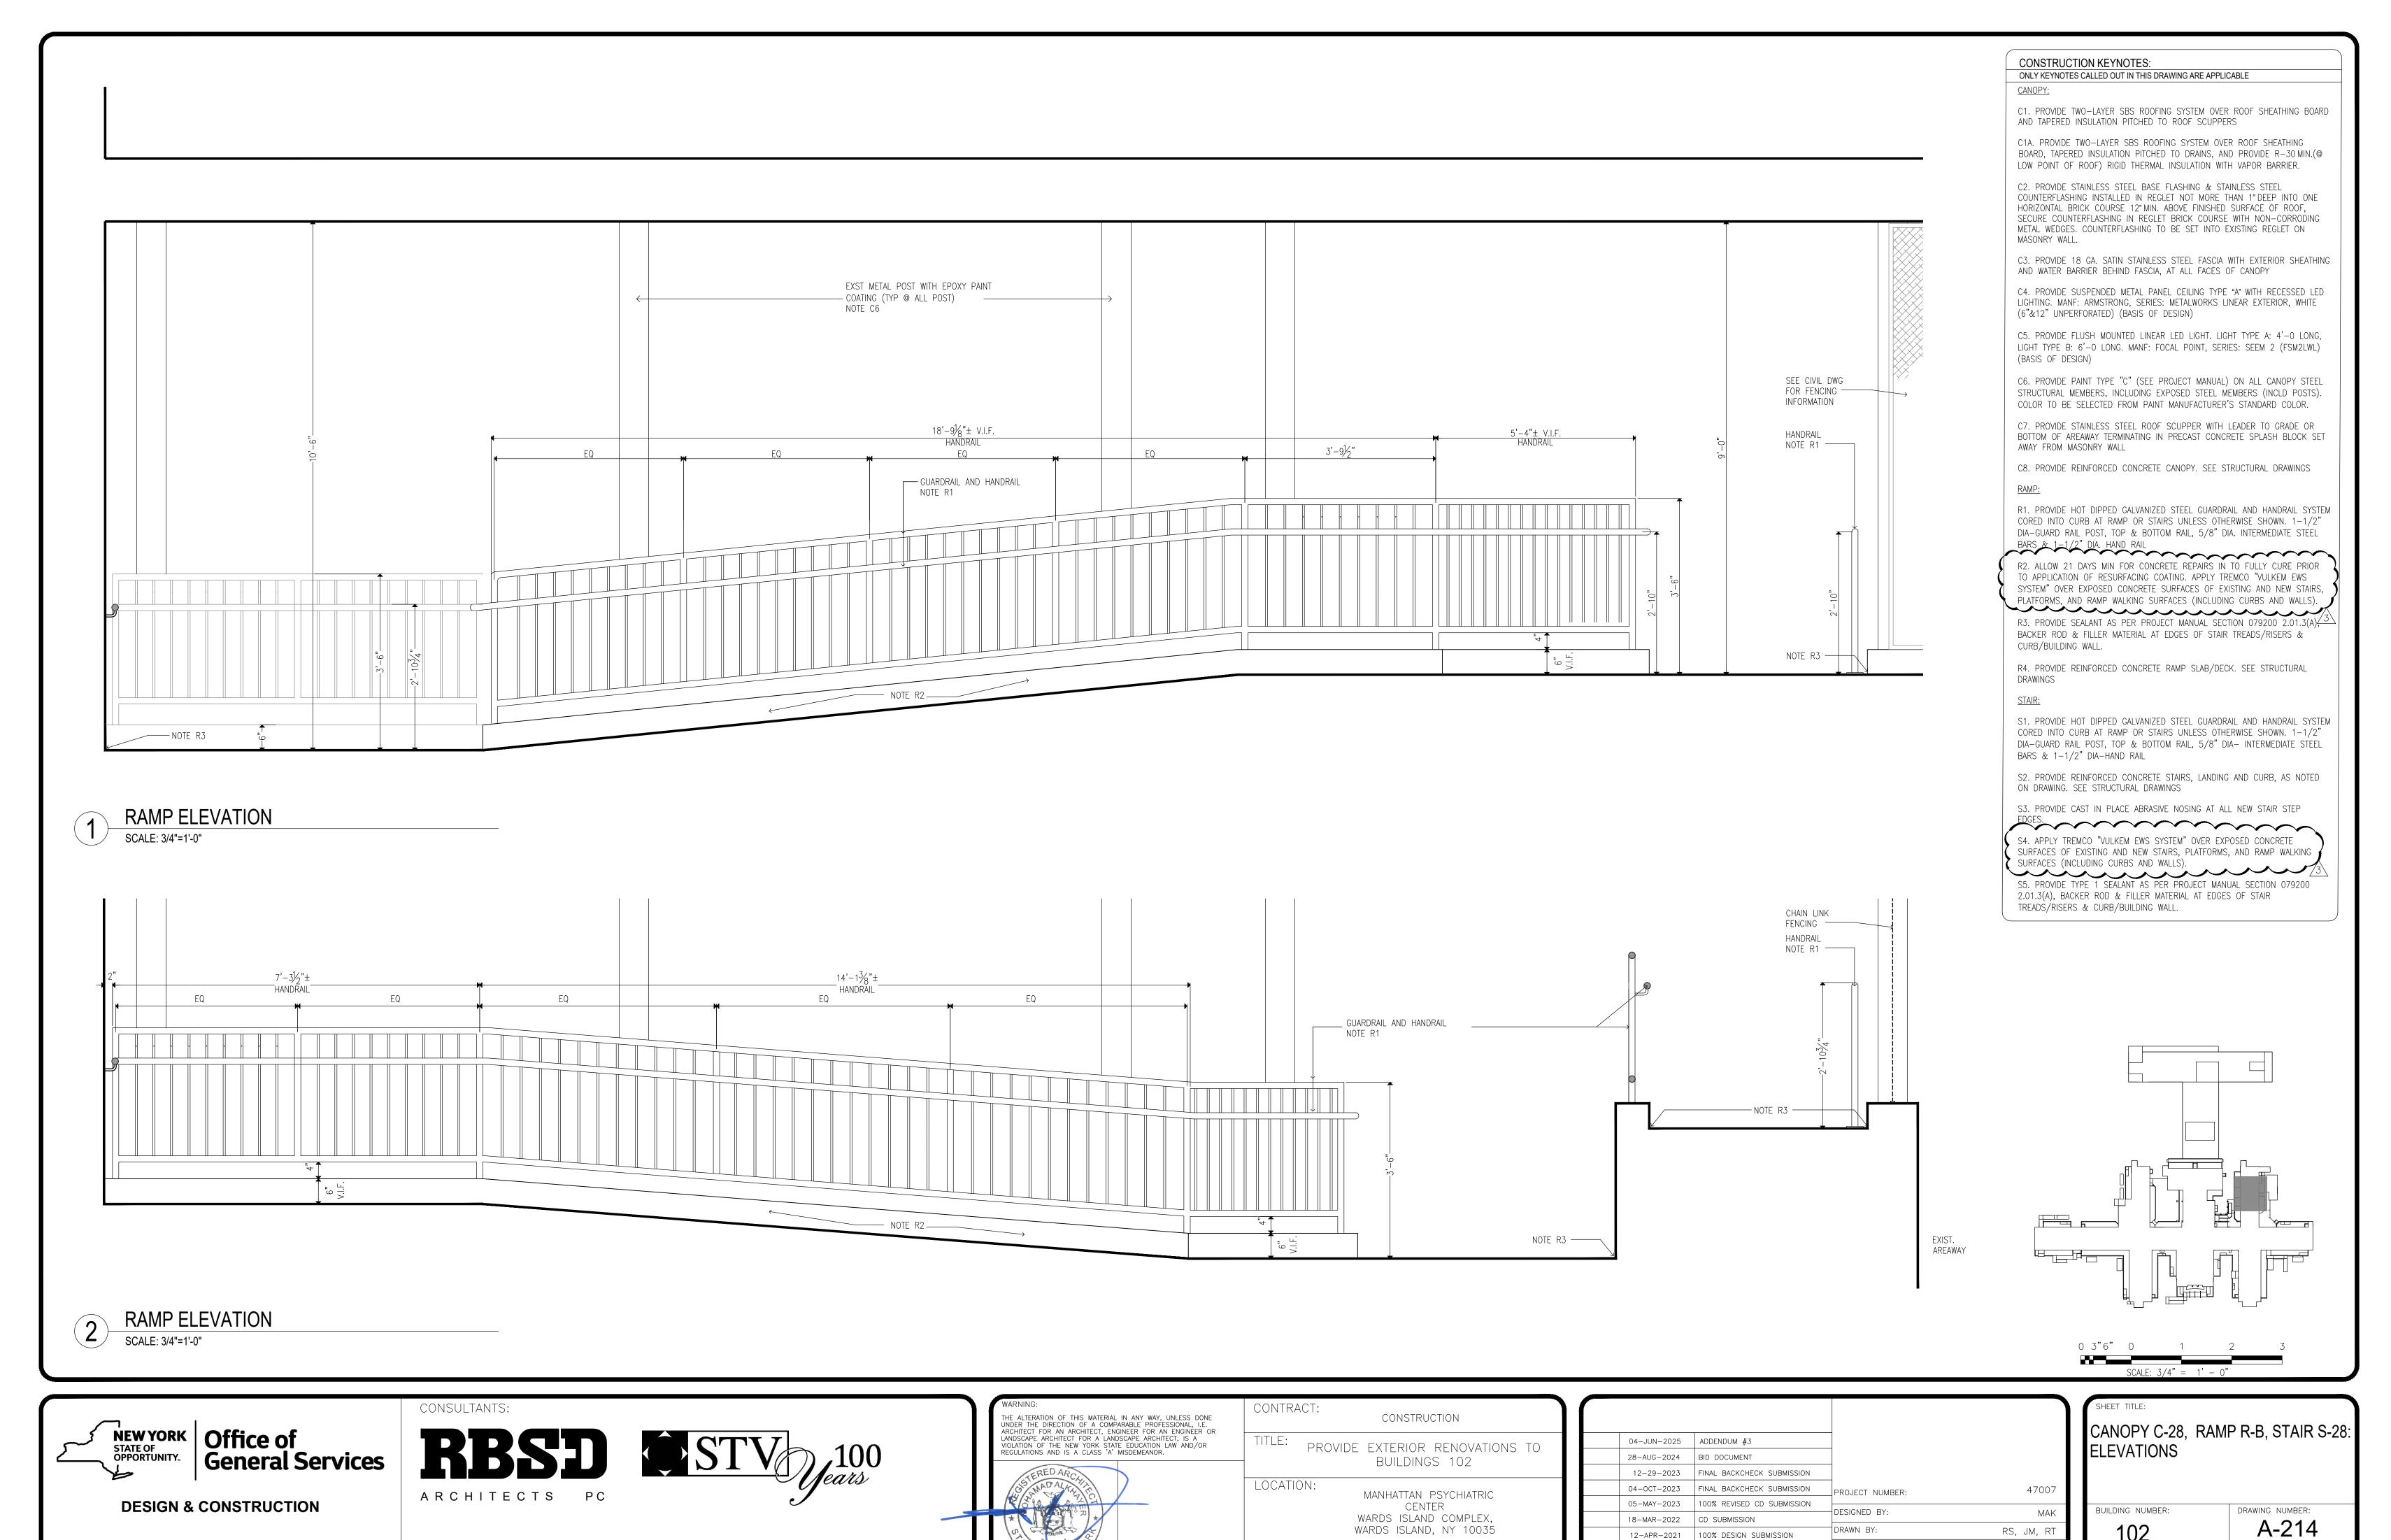
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NYS OFFICE OF MENTAL HEALTH

100% DESIGN SUBMISSION

DESIGN DEVELOPMENT

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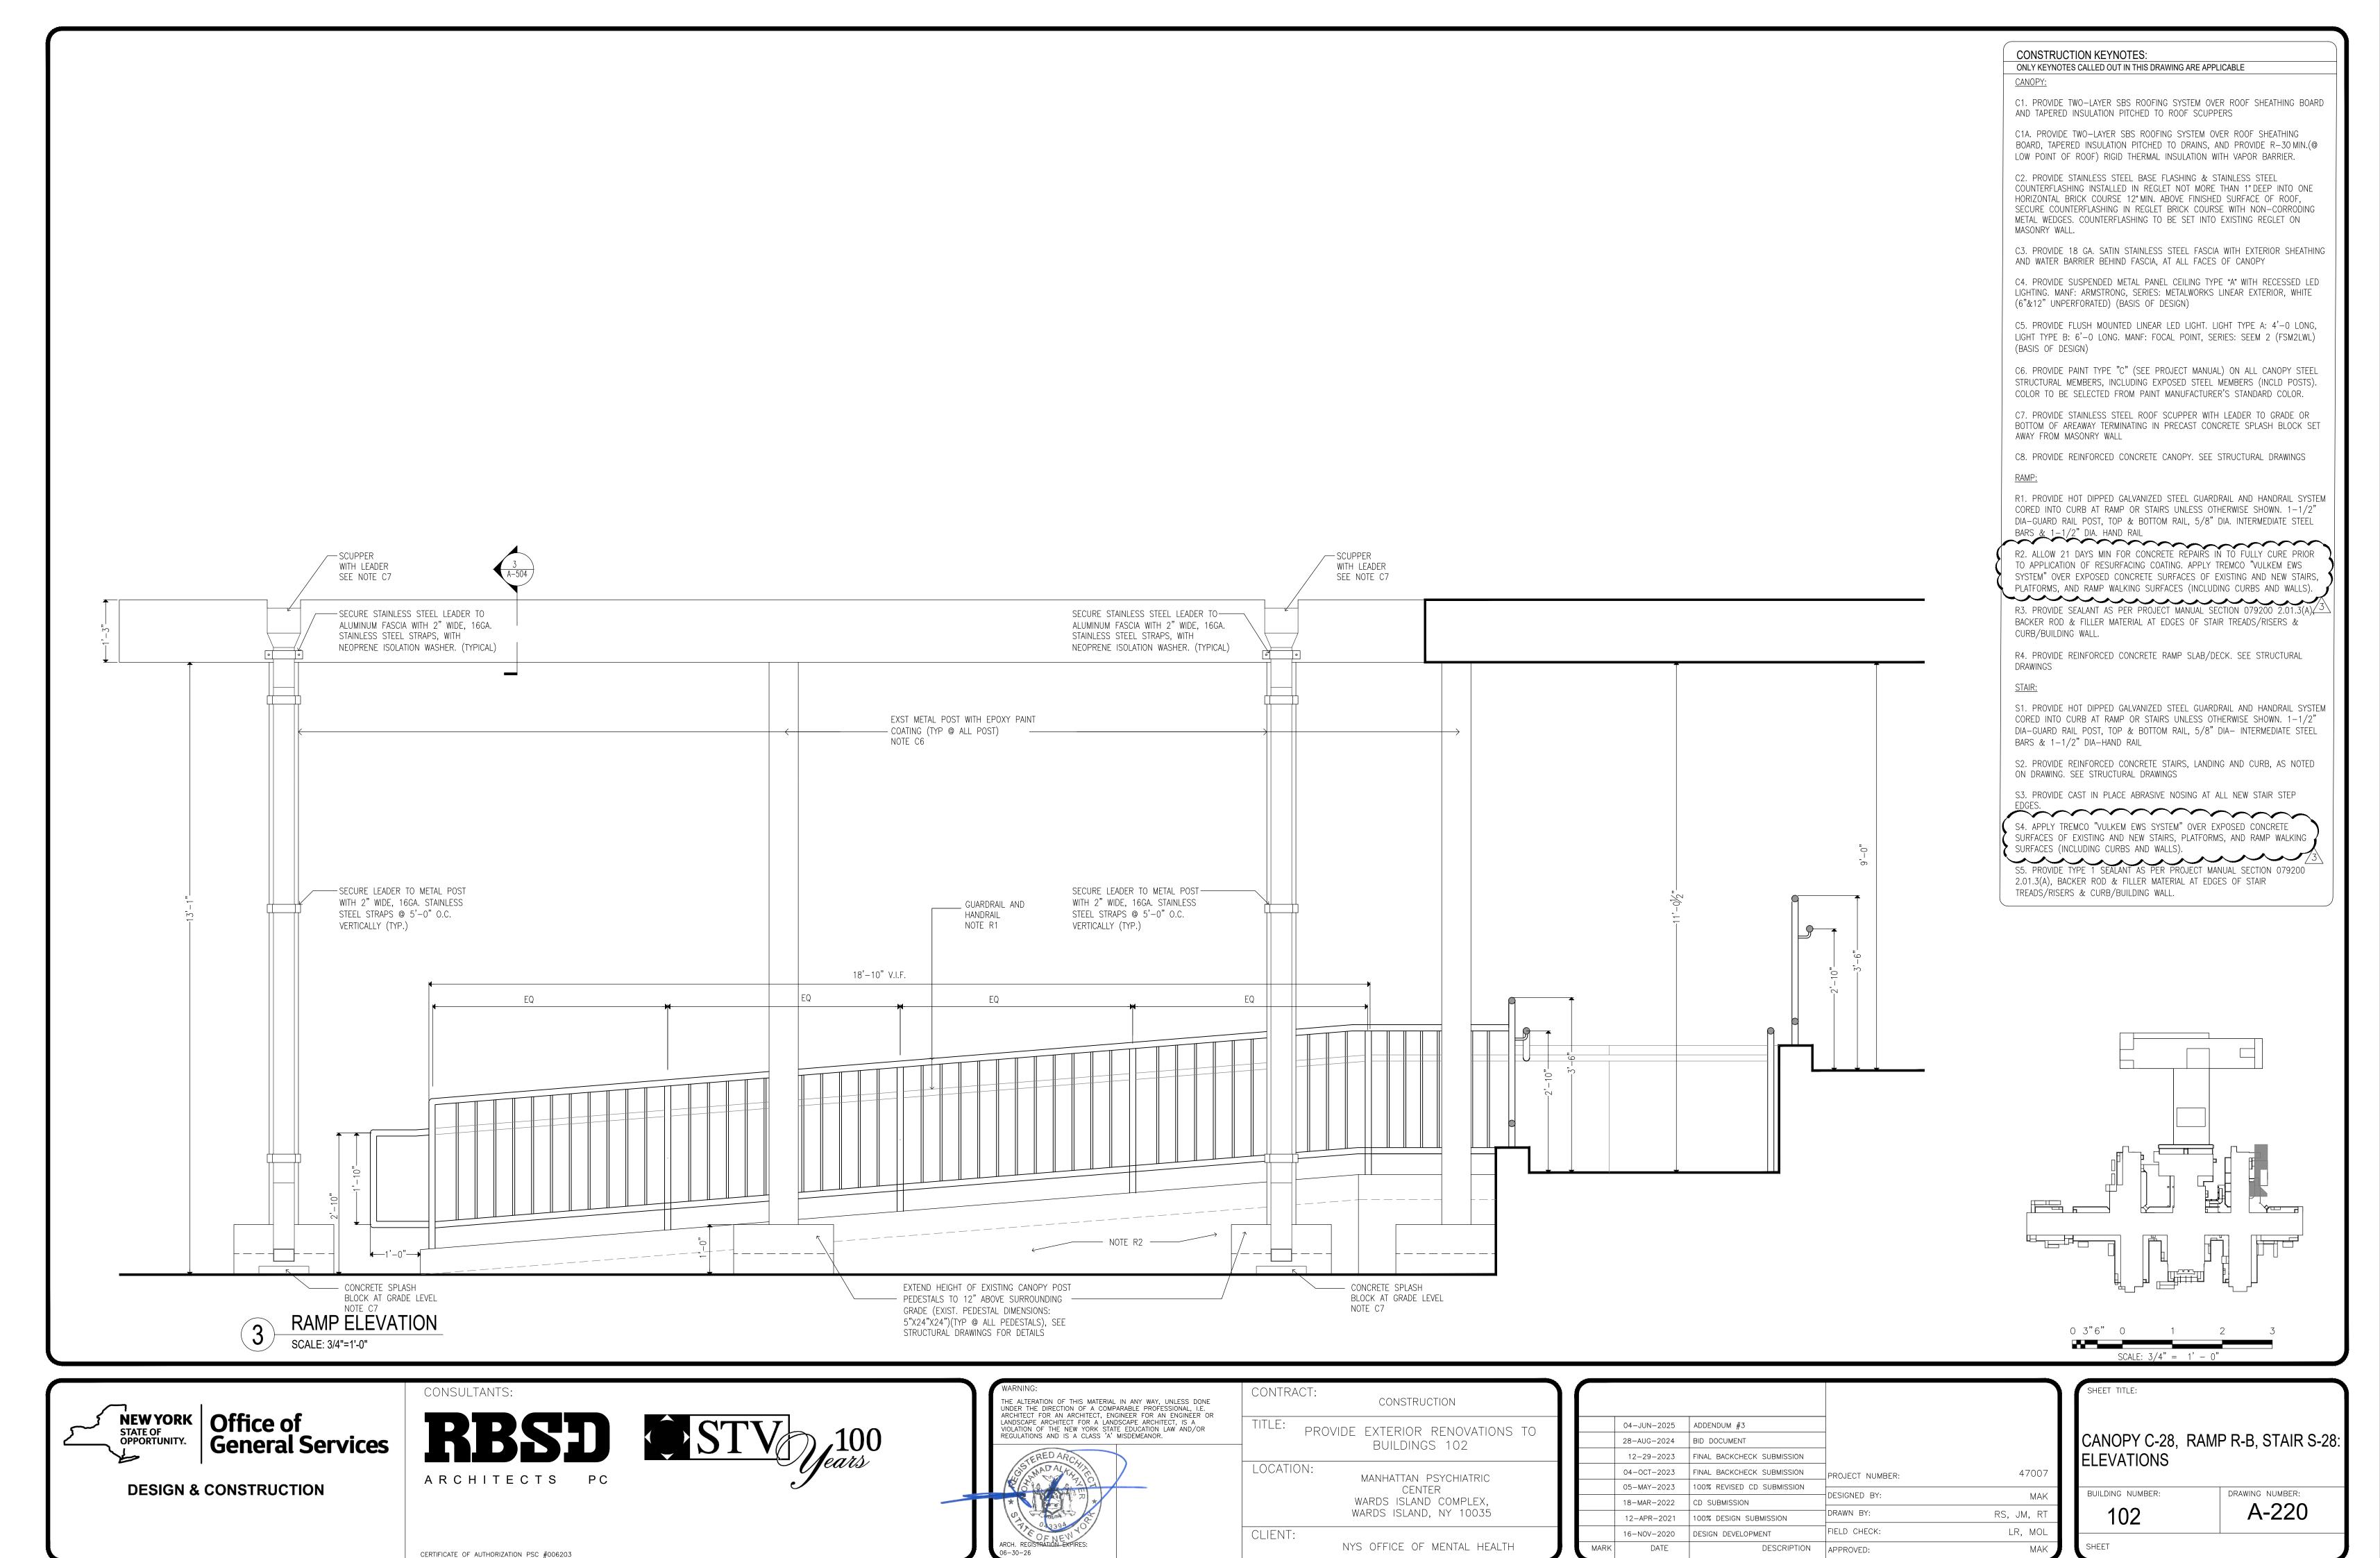
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LR, MOL

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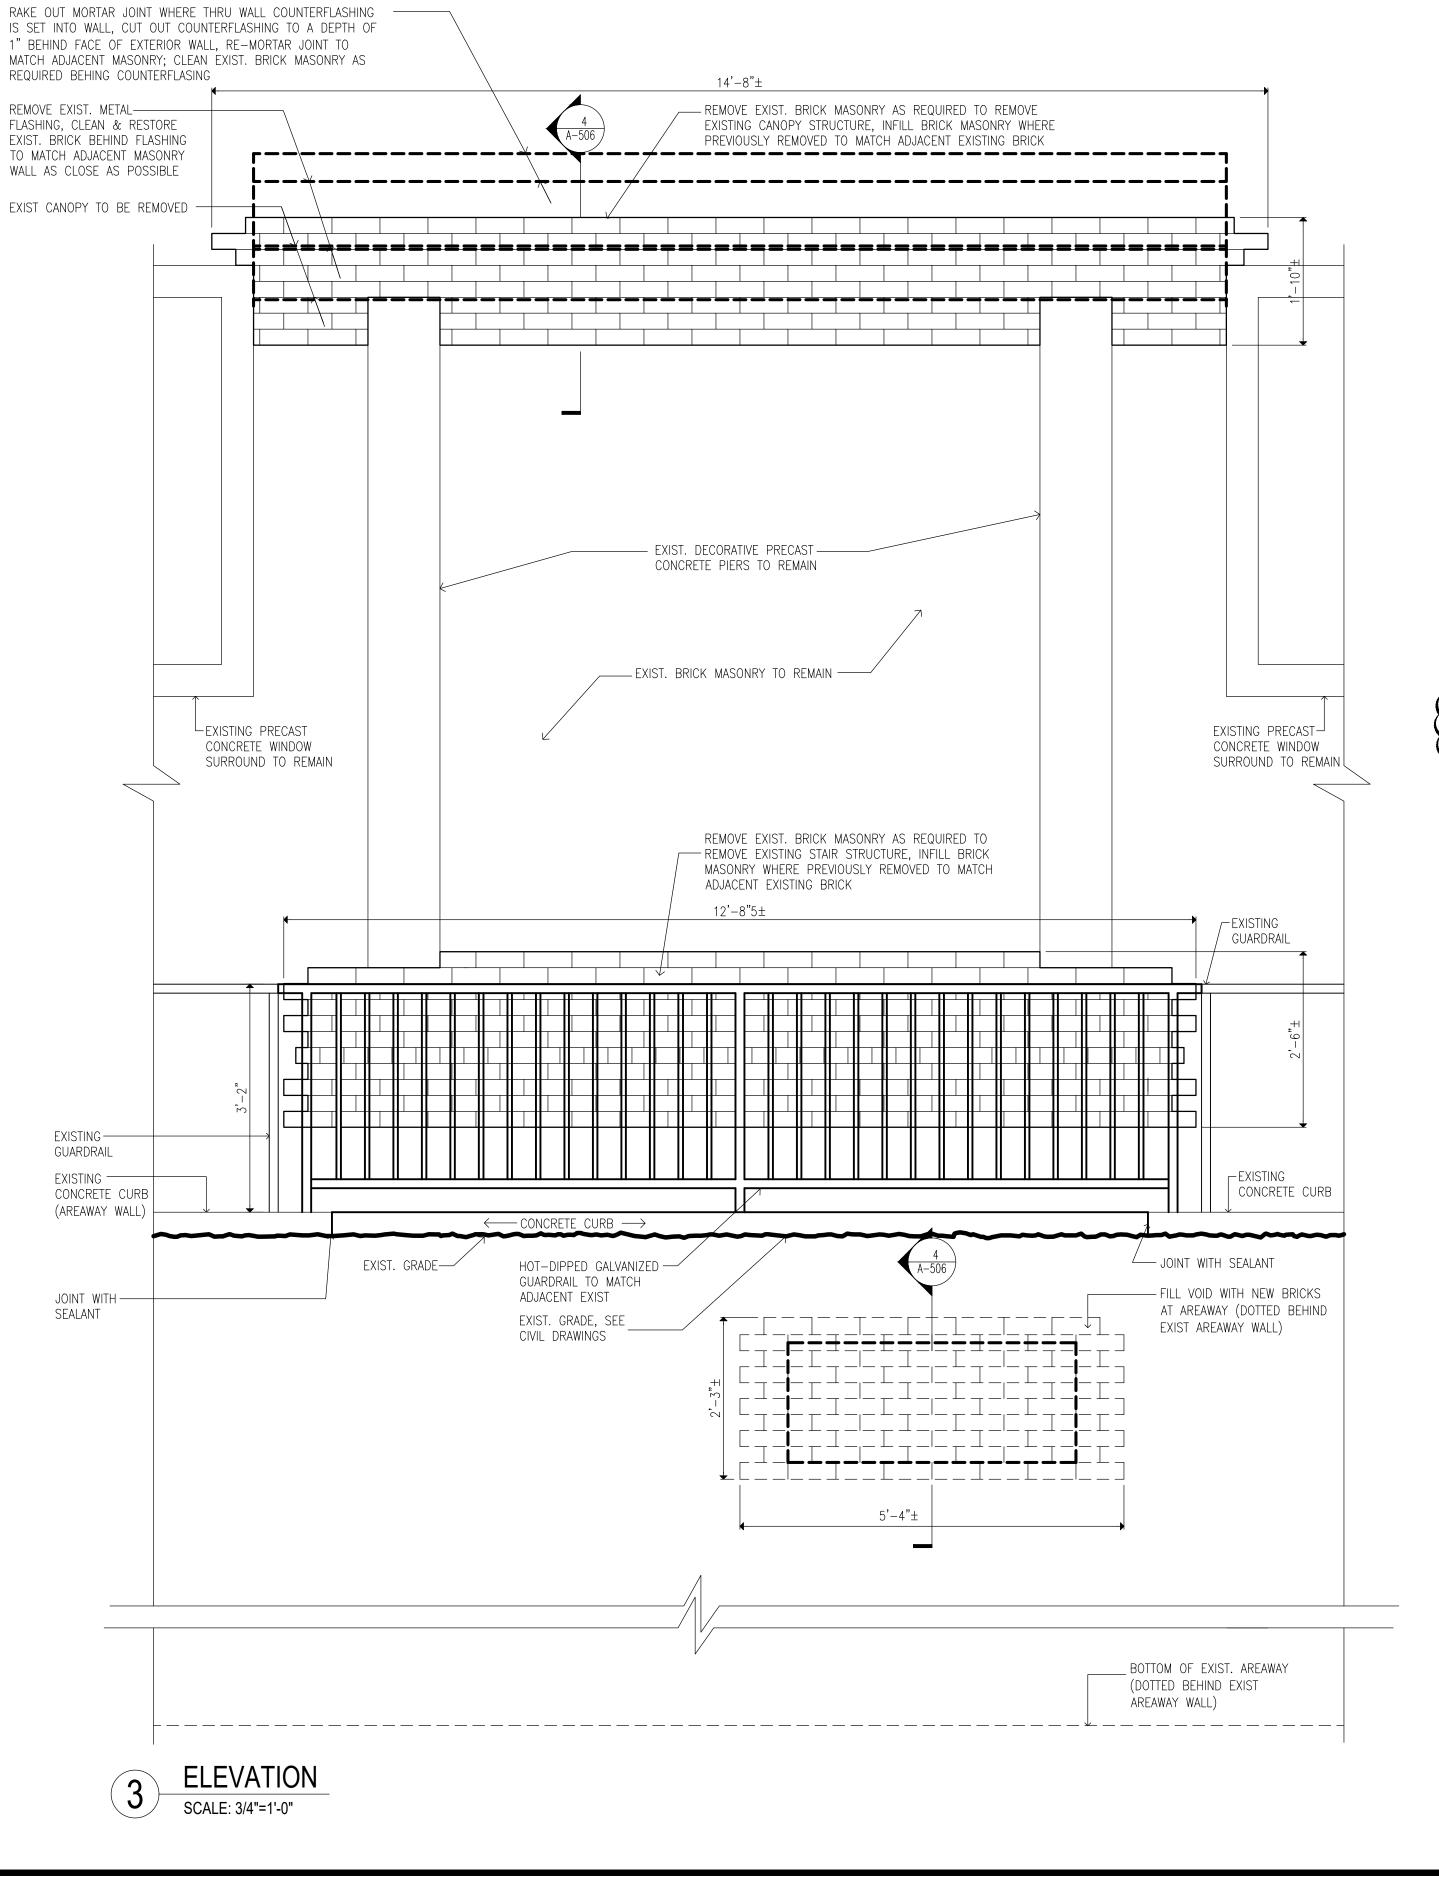
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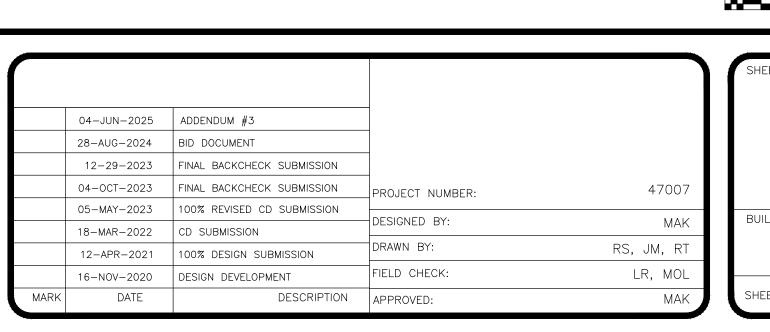
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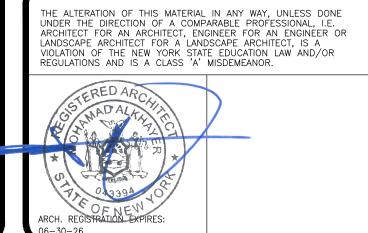




CANOPY C-46, STAIRS S-46: **ELEVATION** BUILDING NUMBER: DRAWING NUMBER: A-222

NEW YORK
STATE OF
OPPORTUNITY.
General Services **DESIGN & CONSTRUCTION** 

CONSULTANTS:



CONTRACT: CONSTRUCTION TITLE: PROVIDE EXTERIOR RENOVATIONS TO BUILDINGS 102 LOCATION: MANHATTAN PSYCHIATRIC CENTER WARDS ISLAND COMPLEX, WARDS ISLAND, NY 10035 CLIENT: NYS OFFICE OF MENTAL HEALTH

CERTIFICATE OF AUTHORIZATION PSC #006203

CONSTRUCTION KEYNOTES:

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AND TAPERED INSULATION PITCHED TO ROOF SCUPPERS

C1. PROVIDE TWO-LAYER SBS ROOFING SYSTEM OVER ROOF SHEATHING BOARD

BOARD, TAPERED INSULATION PITCHED TO DRAINS, AND PROVIDE R-30 MIN.(@

COUNTERFLASHING INSTALLED IN REGLET NOT MORE THAN 1"DEEP INTO ONE HORIZONTAL BRICK COURSE 12" MIN. ABOVE FINISHED SURFACE OF ROOF,

SECURE COUNTERFLASHING IN REGLET BRICK COURSE WITH NON-CORRODING METAL WEDGES. COUNTERFLASHING TO BE SET INTO EXISTING REGLET ON

C3. PROVIDE 18 GA. SATIN STAINLESS STEEL FASCIA WITH EXTERIOR SHEATHING

C4. PROVIDE SUSPENDED METAL PANEL CEILING TYPE "A" WITH RECESSED LED LIGHTING. MANF: ARMSTRONG, SERIES: METALWORKS LINEAR EXTERIOR, WHITE

C5. PROVIDE FLUSH MOUNTED LINEAR LED LIGHT. LIGHT TYPE A: 4'-0 LONG, LIGHT TYPE B: 6'-0 LONG. MANF: FOCAL POINT, SERIES: SEEM 2 (FSM2LWL)

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C8. PROVIDE REINFORCED CONCRETE CANOPY. SEE STRUCTURAL DRAWINGS

R1. PROVIDE HOT DIPPED GALVANIZED STEEL GUARDRAIL AND HANDRAIL SYSTEM CORED INTO CURB AT RAMP OR STAIRS UNLESS OTHERWISE SHOWN. 1-1/2" DIA-GUARD RAIL POST, TOP & BOTTOM RAIL, 5/8" DIA. INTERMEDIATE STEEL BARS & 1-1/2" DIA. HAND RAIL

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R3. PROVIDE SEALANT AS PER PROJECT MANUAL SECTION 079200 2.01.3(A) BACKER ROD & FILLER MATERIAL AT EDGES OF STAIR TREADS/RISERS &

R4. PROVIDE REINFORCED CONCRETE RAMP SLAB/DECK. SEE STRUCTURAL

S1. PROVIDE HOT DIPPED GALVANIZED STEEL GUARDRAIL AND HANDRAIL SYSTEM

CORED INTO CURB AT RAMP OR STAIRS UNLESS OTHERWISE SHOWN. 1-1/2"

DIA-GUARD RAIL POST, TOP & BOTTOM RAIL, 5/8" DIA- INTERMEDIATE STEEL

S2. PROVIDE REINFORCED CONCRETE STAIRS, LANDING AND CURB, AS NOTED

S3. PROVIDE CAST IN PLACE ABRASIVE NOSING AT ALL NEW STAIR STEP FILLED. S4. APPLY TREMCO "VULKEM EWS SYSTEM" OVER EXPOSED CONCRETE SURFACES OF EXISTING AND NEW STAIRS, PLATFORMS, AND RAMP WALKING

S5. PROVIDE TYPE 1 SEALANT AS PER PROJECT MANUAL SECTION 079200

2.01.3(A), BACKER ROD & FILLER MATERIAL AT EDGES OF STAIR

C1A. PROVIDE TWO-LAYER SBS ROOFING SYSTEM OVER ROOF SHEATHING

LOW POINT OF ROOF) RIGID THERMAL INSULATION WITH VAPOR BARRIER.

C2. PROVIDE STAINLESS STEEL BASE FLASHING & STAINLESS STEEL

AND WATER BARRIER BEHIND FASCIA, AT ALL FACES OF CANOPY

(6"&12" UNPERFORATED) (BASIS OF DESIGN)

(BASIS OF DESIGN)

AWAY FROM MASONRY WALL

CURB/BUILDING WALL.


BARS & 1-1/2" DIA-HAND RAIL

ON DRAWING. SEE STRUCTURAL DRAWINGS


SURFACES (INCLUDING CURBS AND WALLS).

TREADS/RISERS & CURB/BUILDING WALL.


DRAWINGS

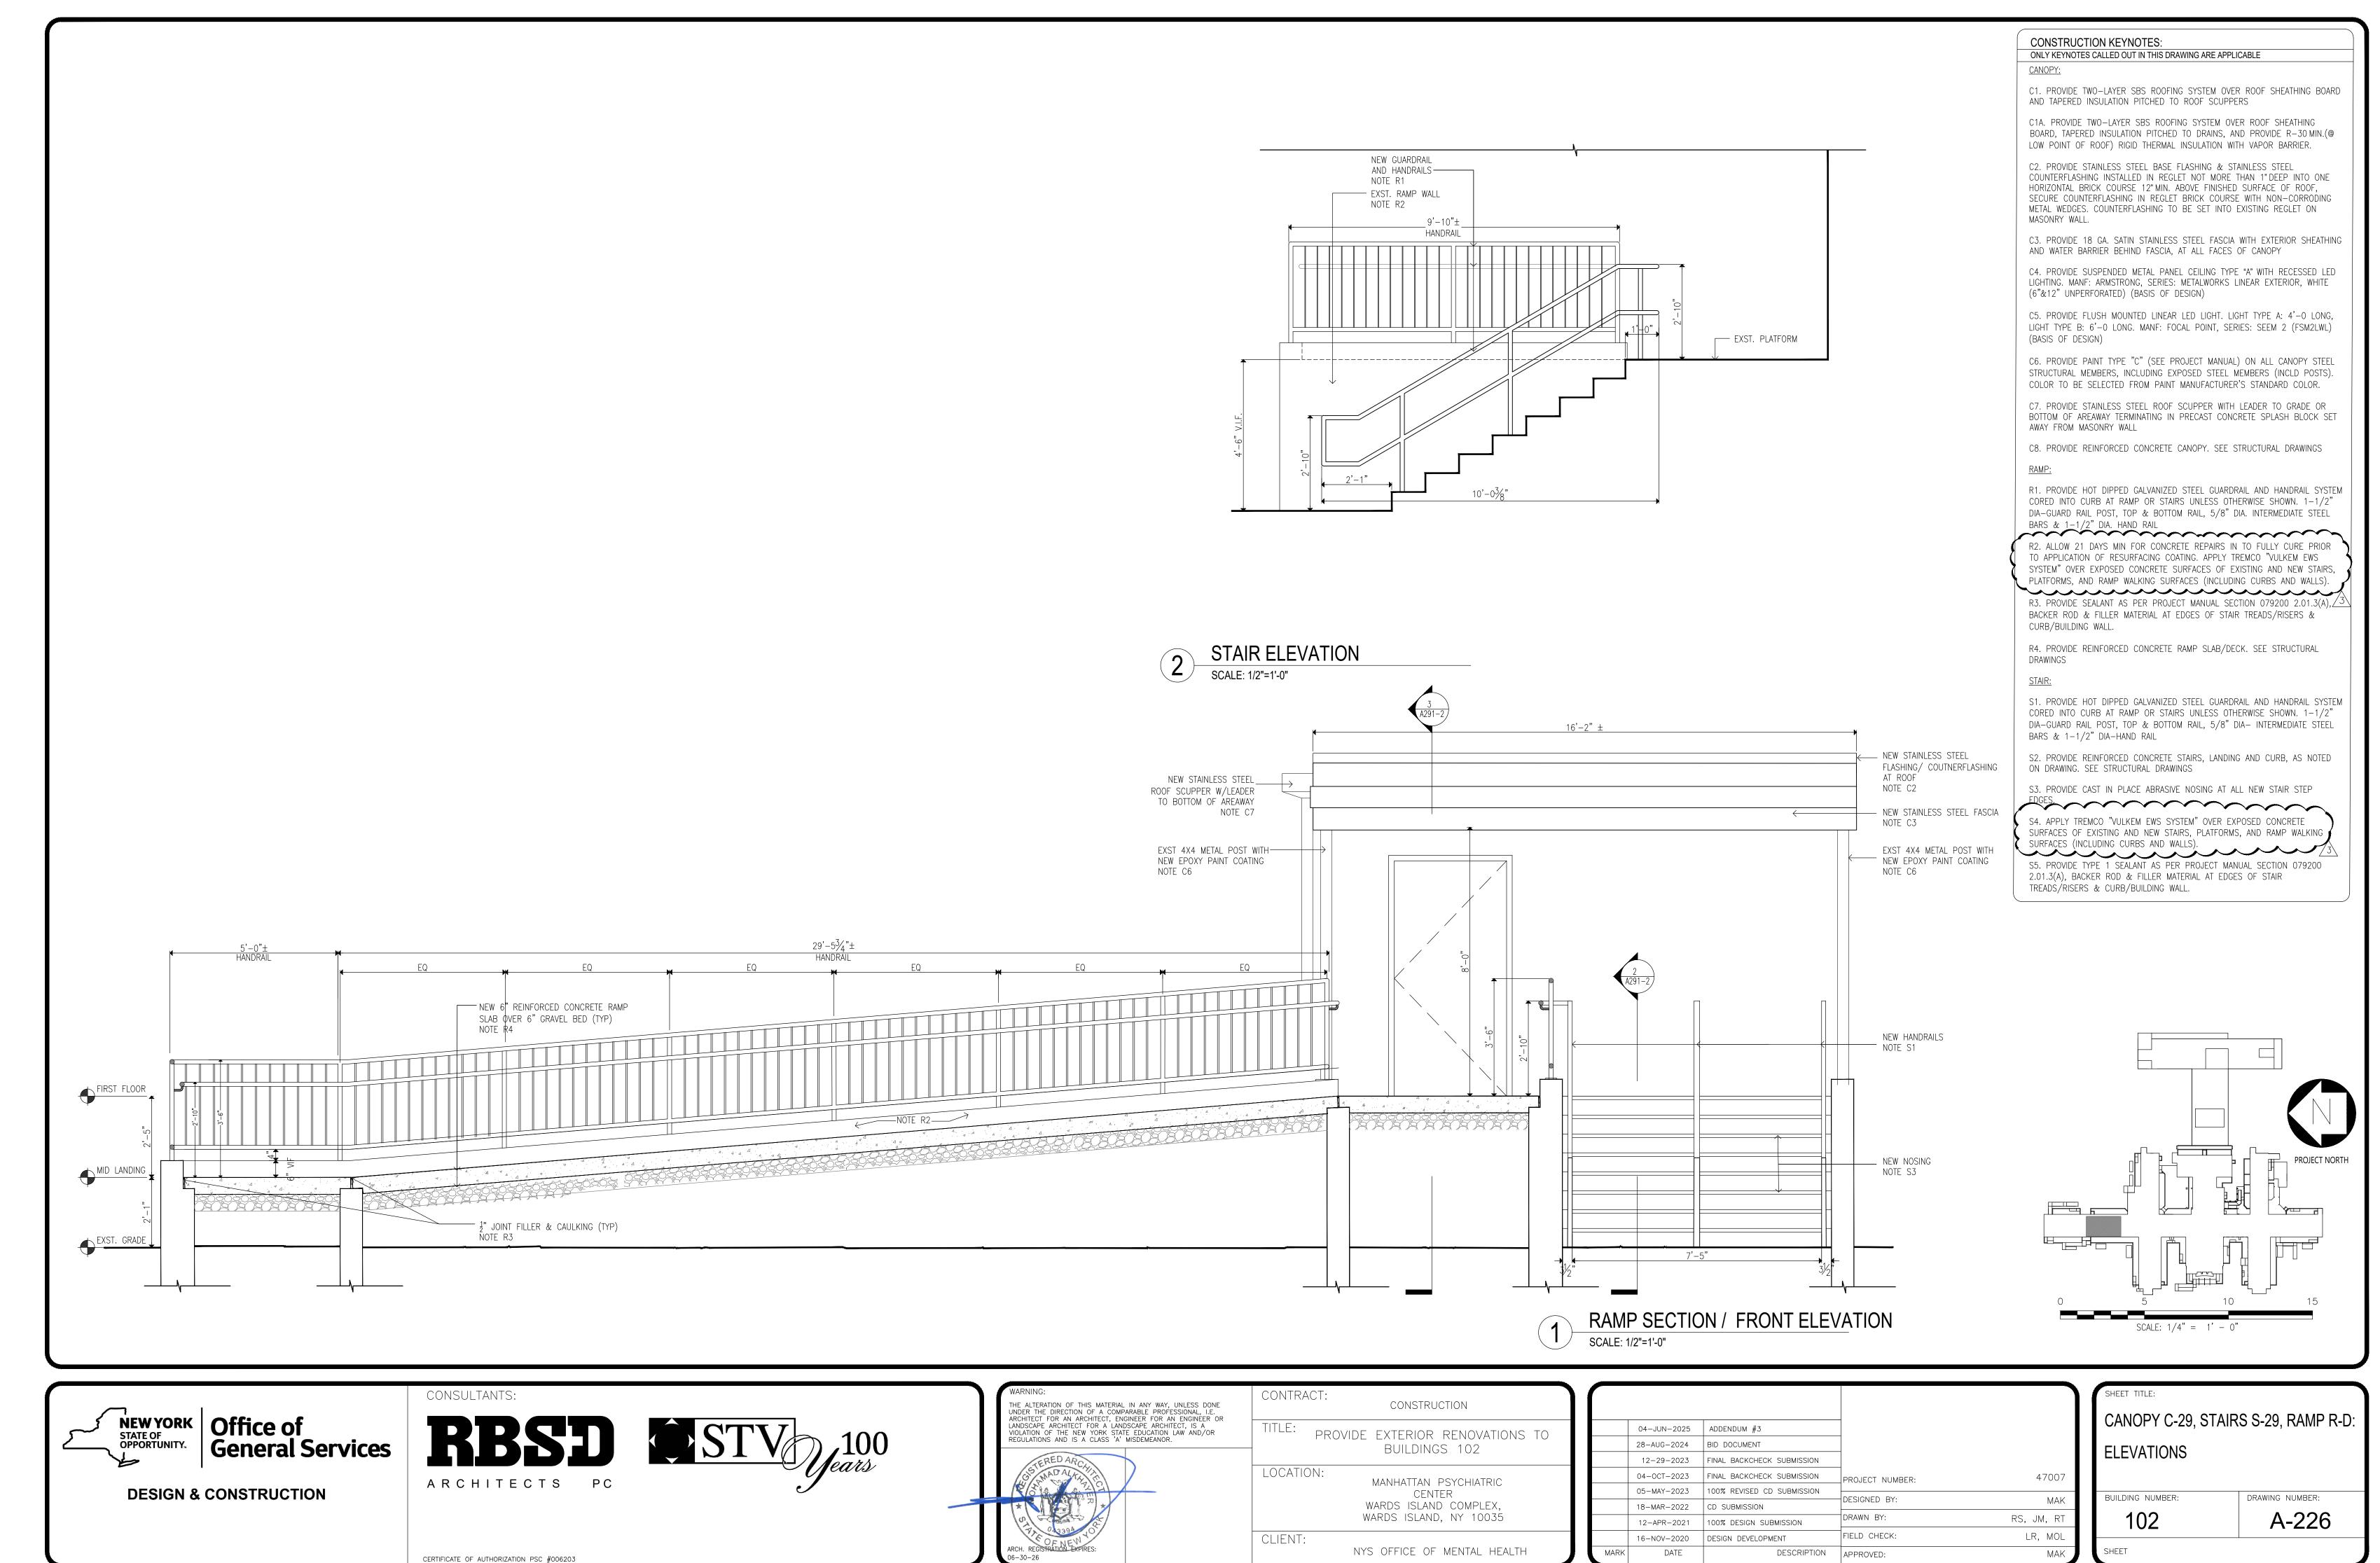

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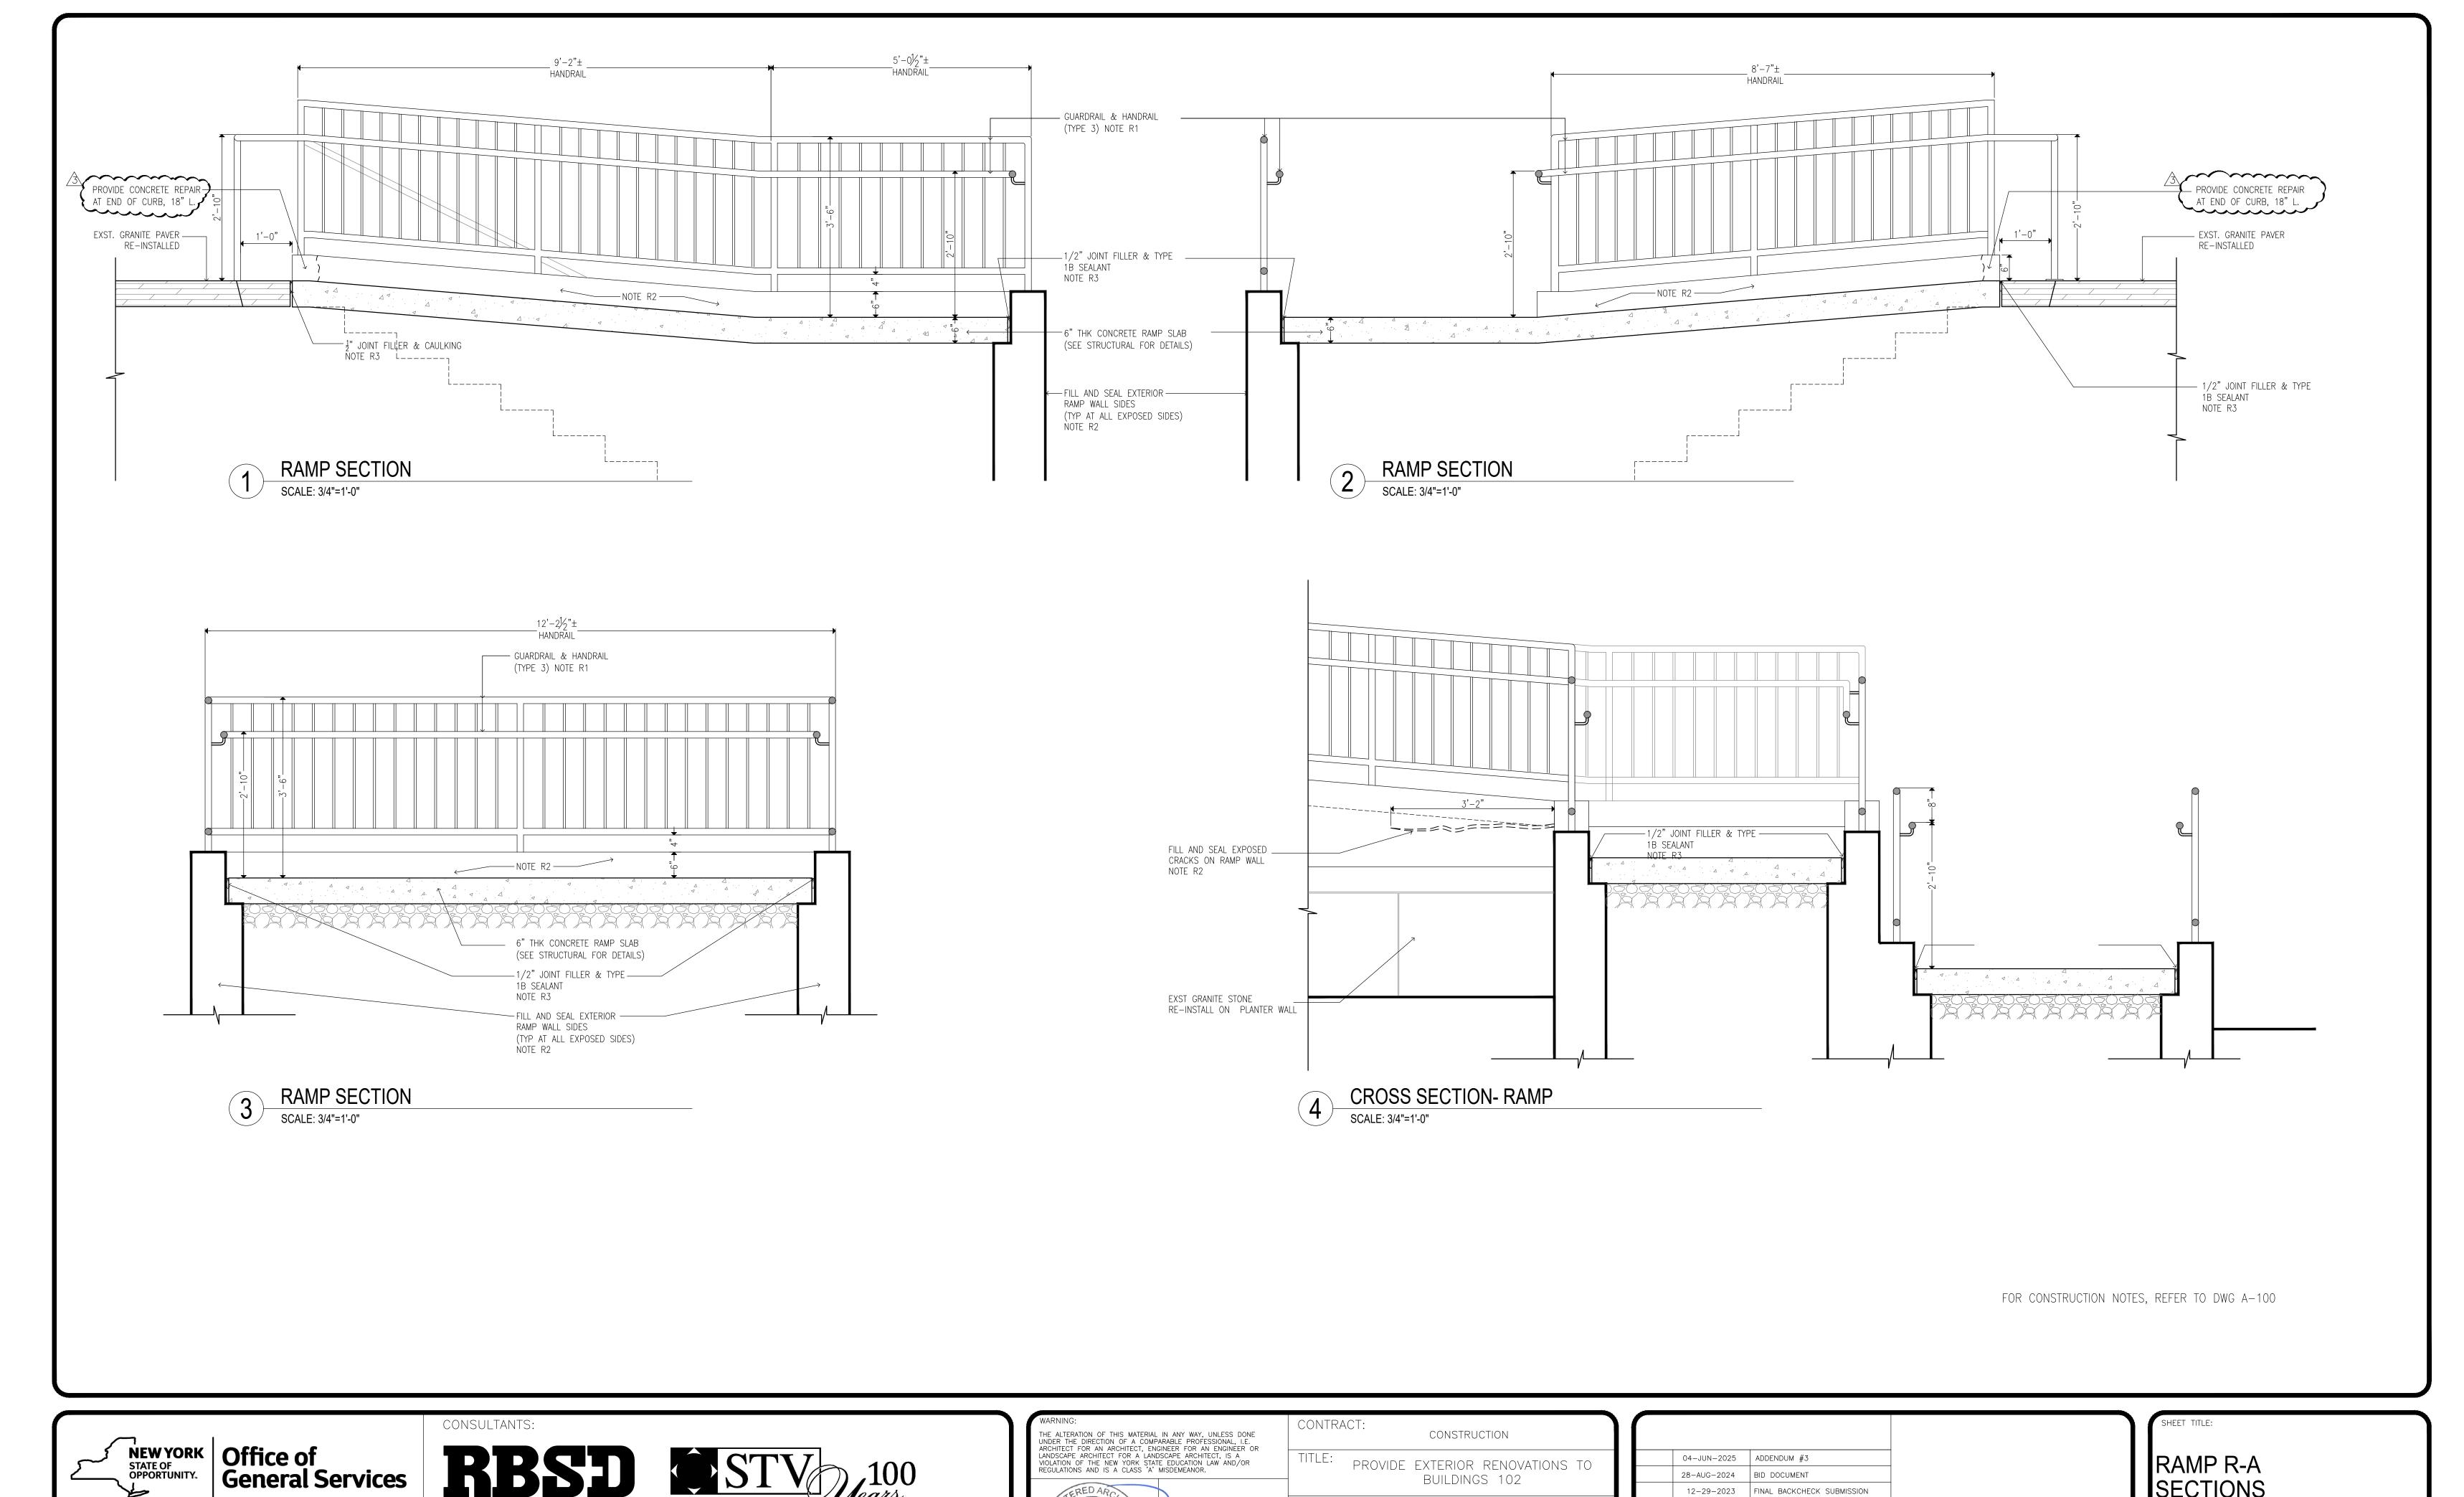


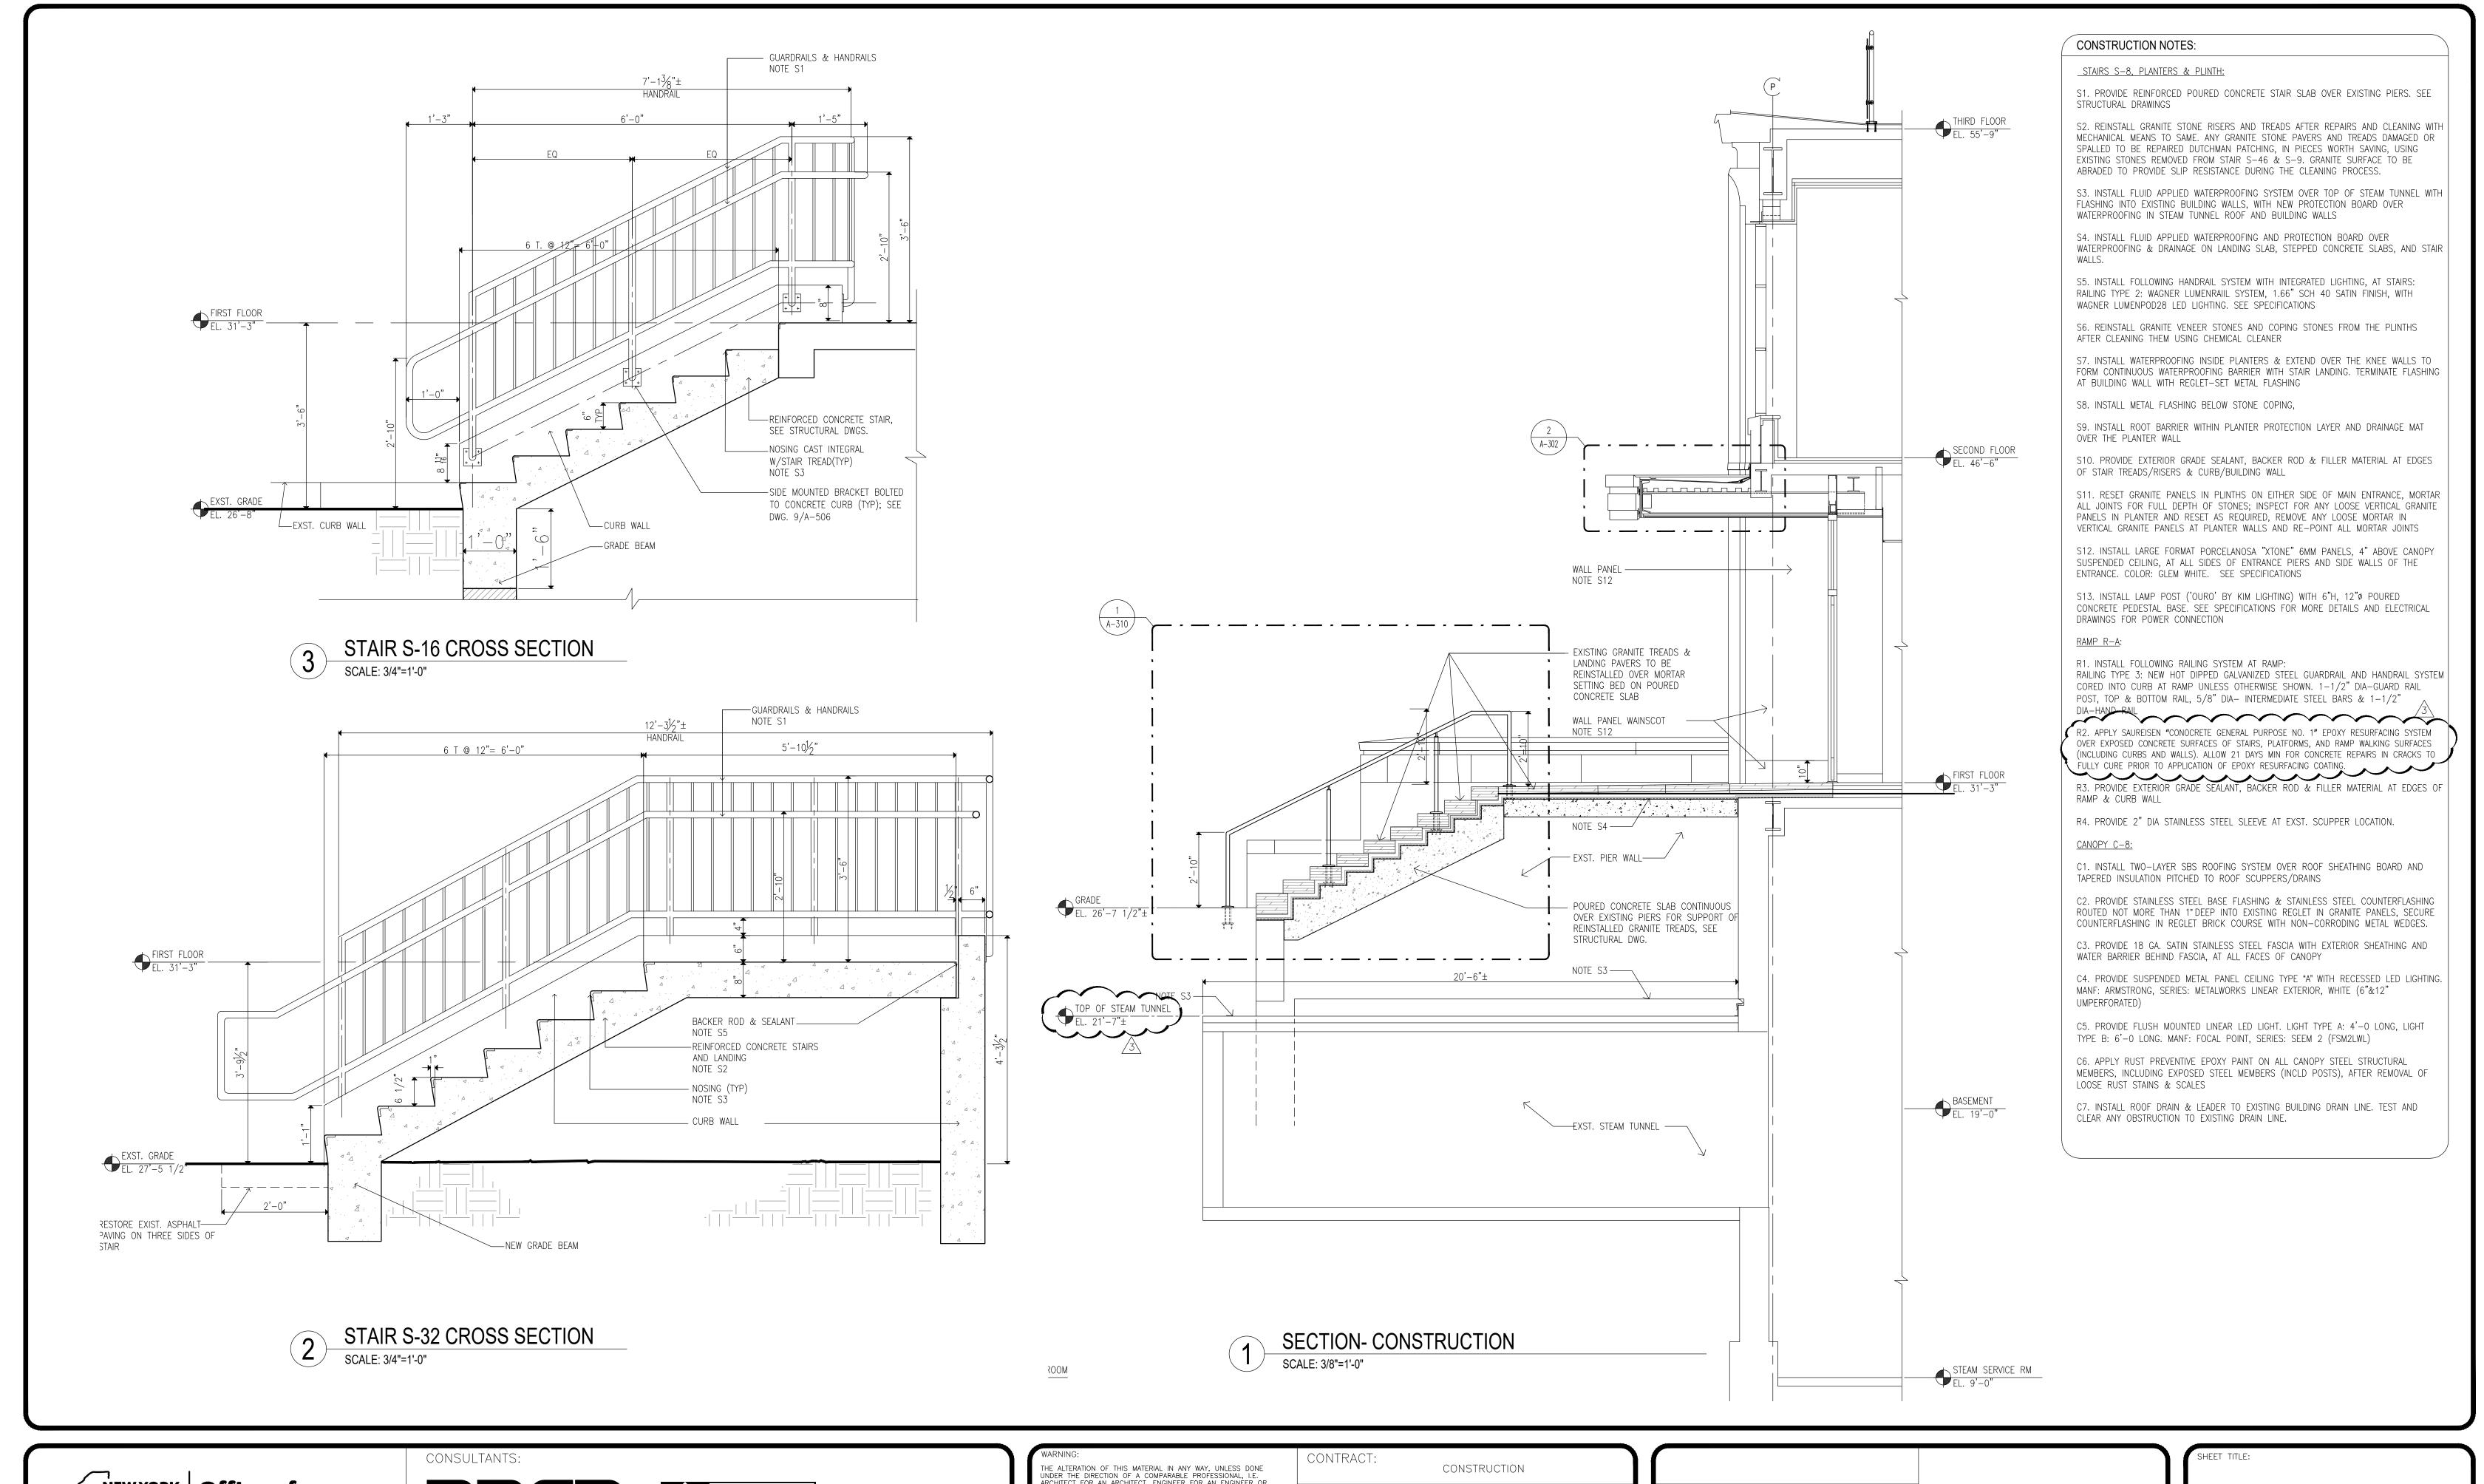

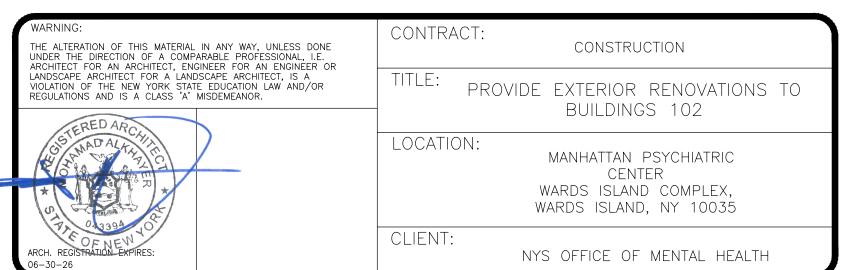

		ADDENDUM #3	04-JUN-2025	
		BID DOCUMENT	28-AUG-2024	
		FINAL BACKCHECK SUBMISSION	12-29-2023	
47007	PROJECT NUMBER:	FINAL BACKCHECK SUBMISSION	04-OCT-2023	
	DECIONED DV	100% REVISED CD SUBMISSION	05-MAY-2023	
MAK	DESIGNED BY:	CD SUBMISSION	18-MAR-2022	
RS, JM, RT	DRAWN BY:	100% DESIGN SUBMISSION	12-APR-2021	
LR, MOL	FIELD CHECK:	DESIGN DEVELOPMENT	16-NOV-2020	
MAK	APPROVED:	DESCRIPTION	DATE	MARK

STAIR #8, ST & STAIR S-32	
BUILDING NUMBER:	DRAWING NUMBER:
102	A-300



BUILDINGS 102

MANHATTAN PSYCHIATRIC

CENTER

WARDS ISLAND COMPLEX,

WARDS ISLAND, NY 10035

NYS OFFICE OF MENTAL HEALTH

LOCATION:

CLIENT:

28-AUG-2024 BID DOCUMENT

05-MAY-2023

DATE

12-29-2023 FINAL BACKCHECK SUBMISSION

12-APR-2021 | 100% DESIGN SUBMISSION

16-NOV-2020 DESIGN DEVELOPMENT

FINAL BACKCHECK SUBMISSION

100% REVISED CD SUBMISSION

PROJECT NUMBER:

DESIGNED BY:

RAWN BY:

FIELD CHECK:

DESCRIPTION APPROVED:

SECTIONS

DRAWING NUMBER:

A-304

47007

RS, JM, R


LR, MOL

MAK

MAK



**DESIGN & CONSTRUCTION** 

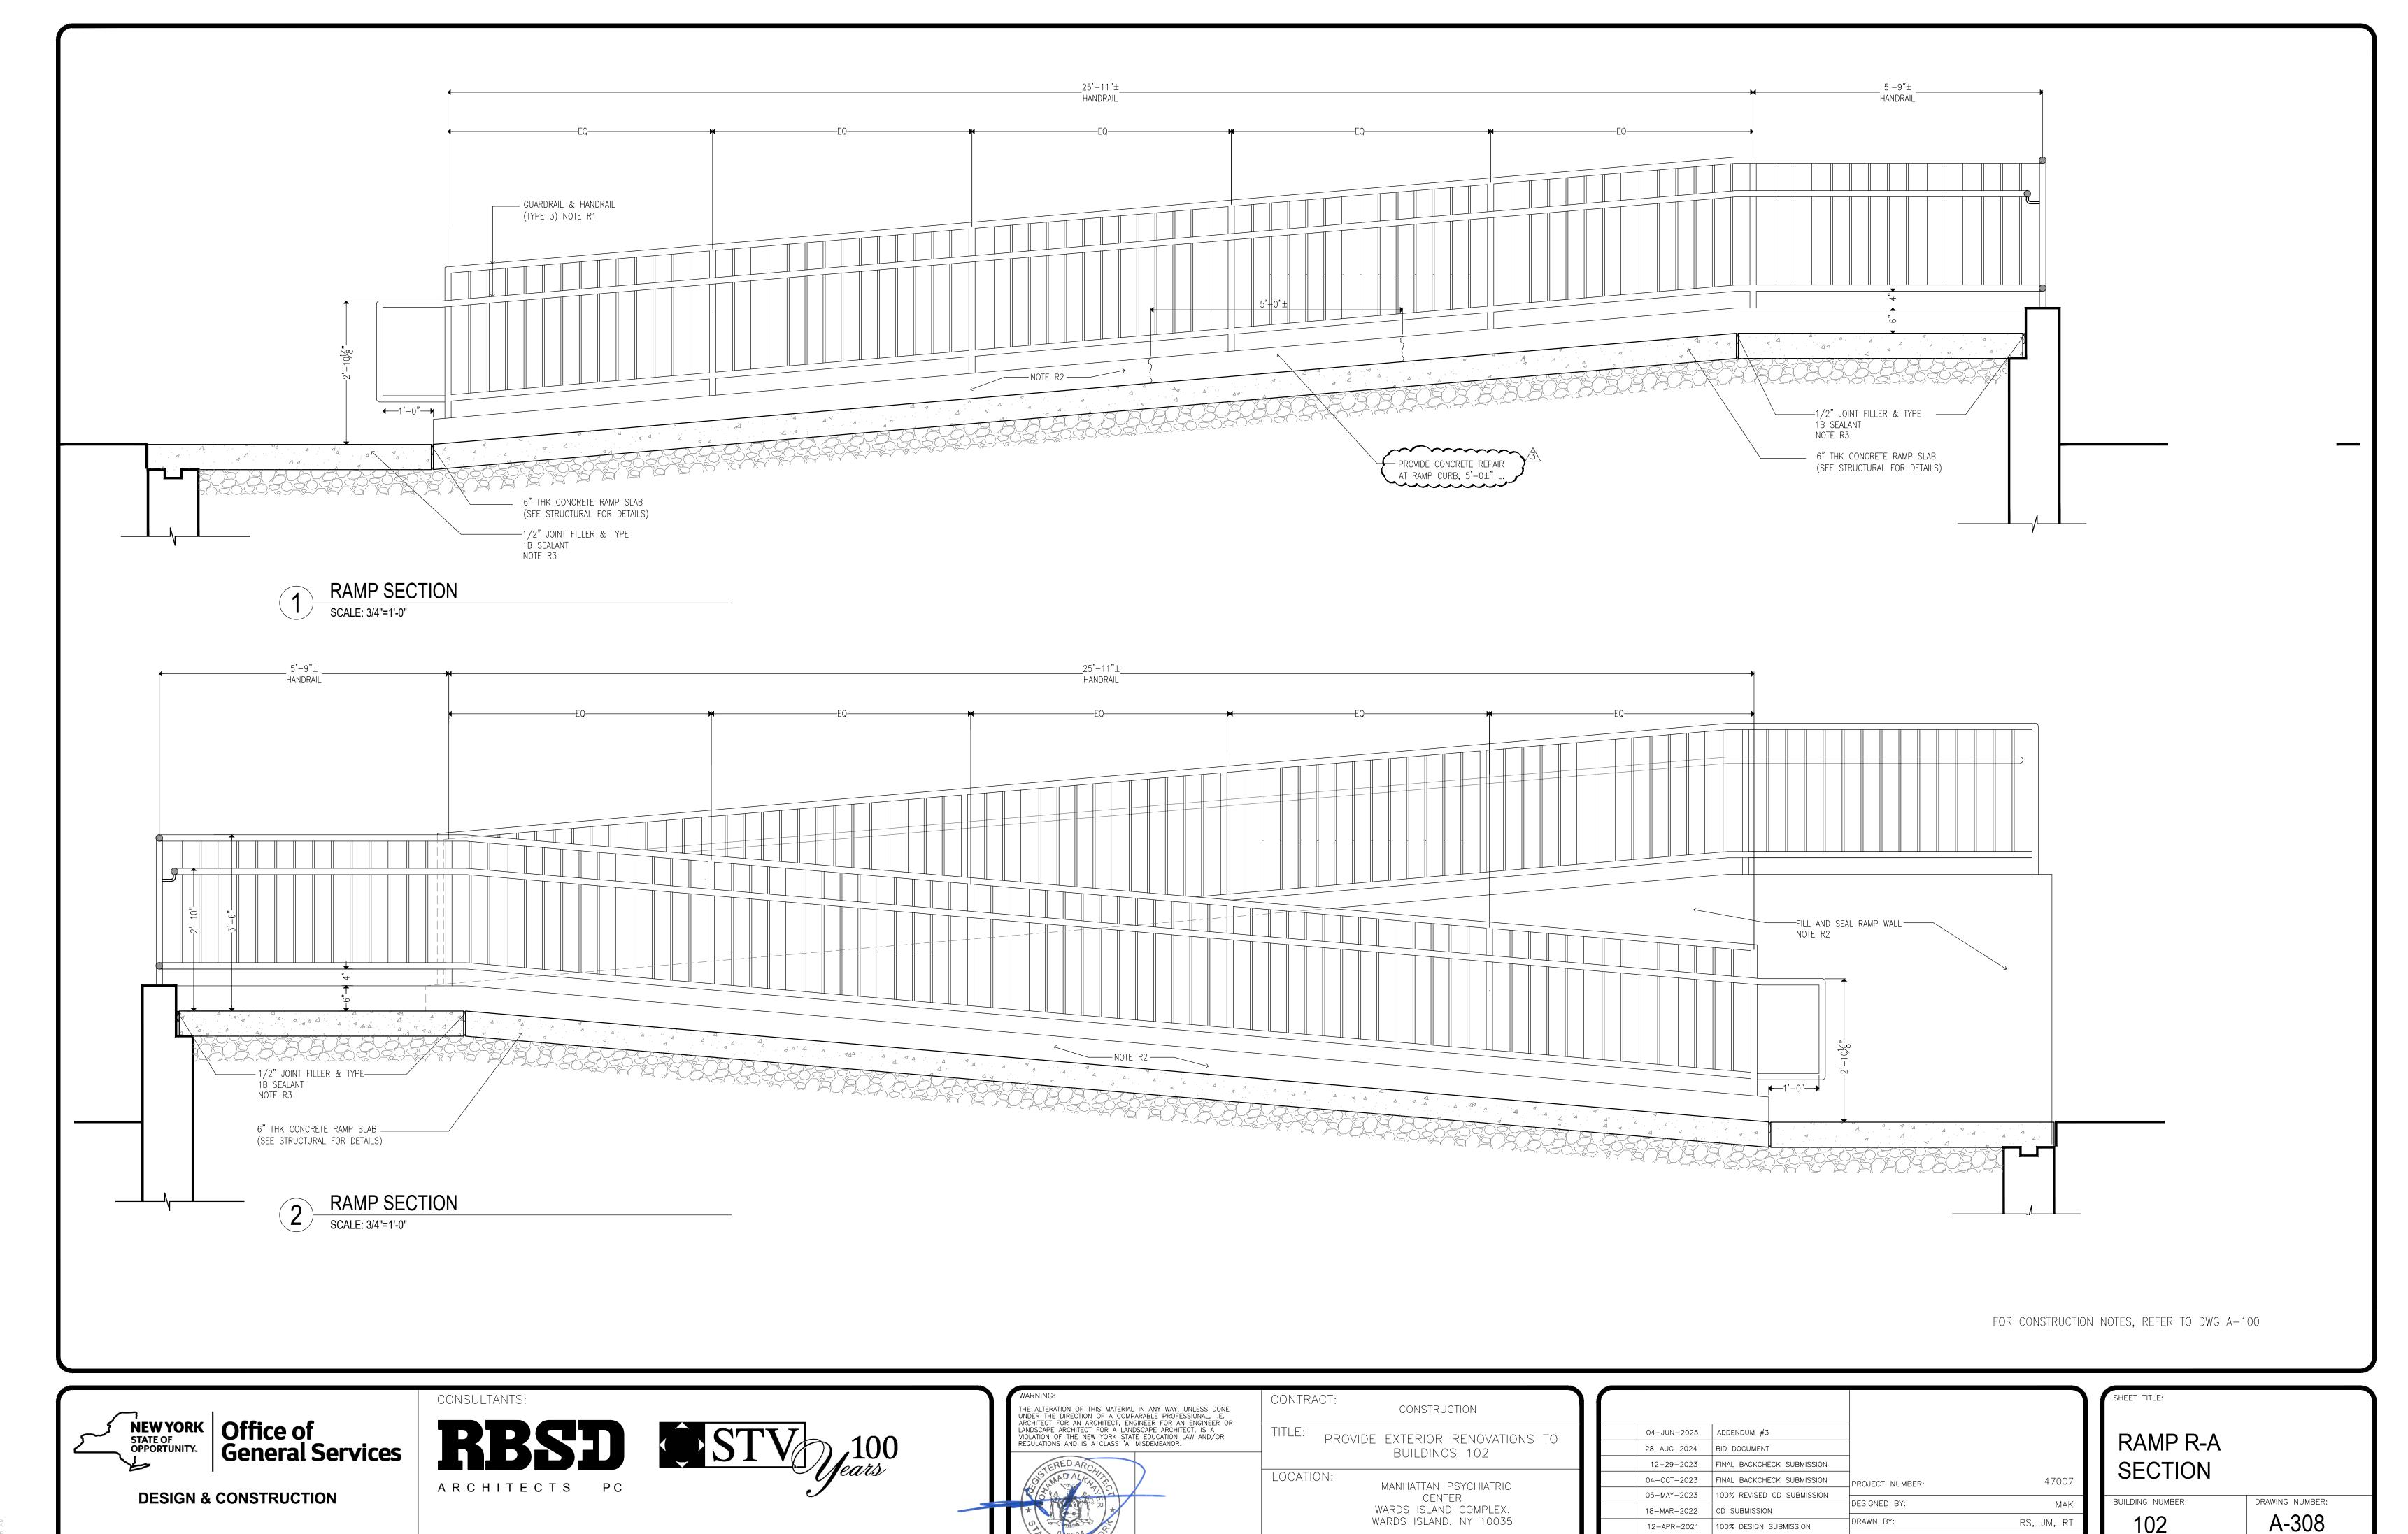

NYS OFFICE OF MENTAL HEALTH

12-APR-2021 | 100% DESIGN SUBMISSION

DESIGN DEVELOPMENT

16-NOV-2020


DATE

FIELD CHECK:

DESCRIPTION APPROVED:

LR, MOL


MAK

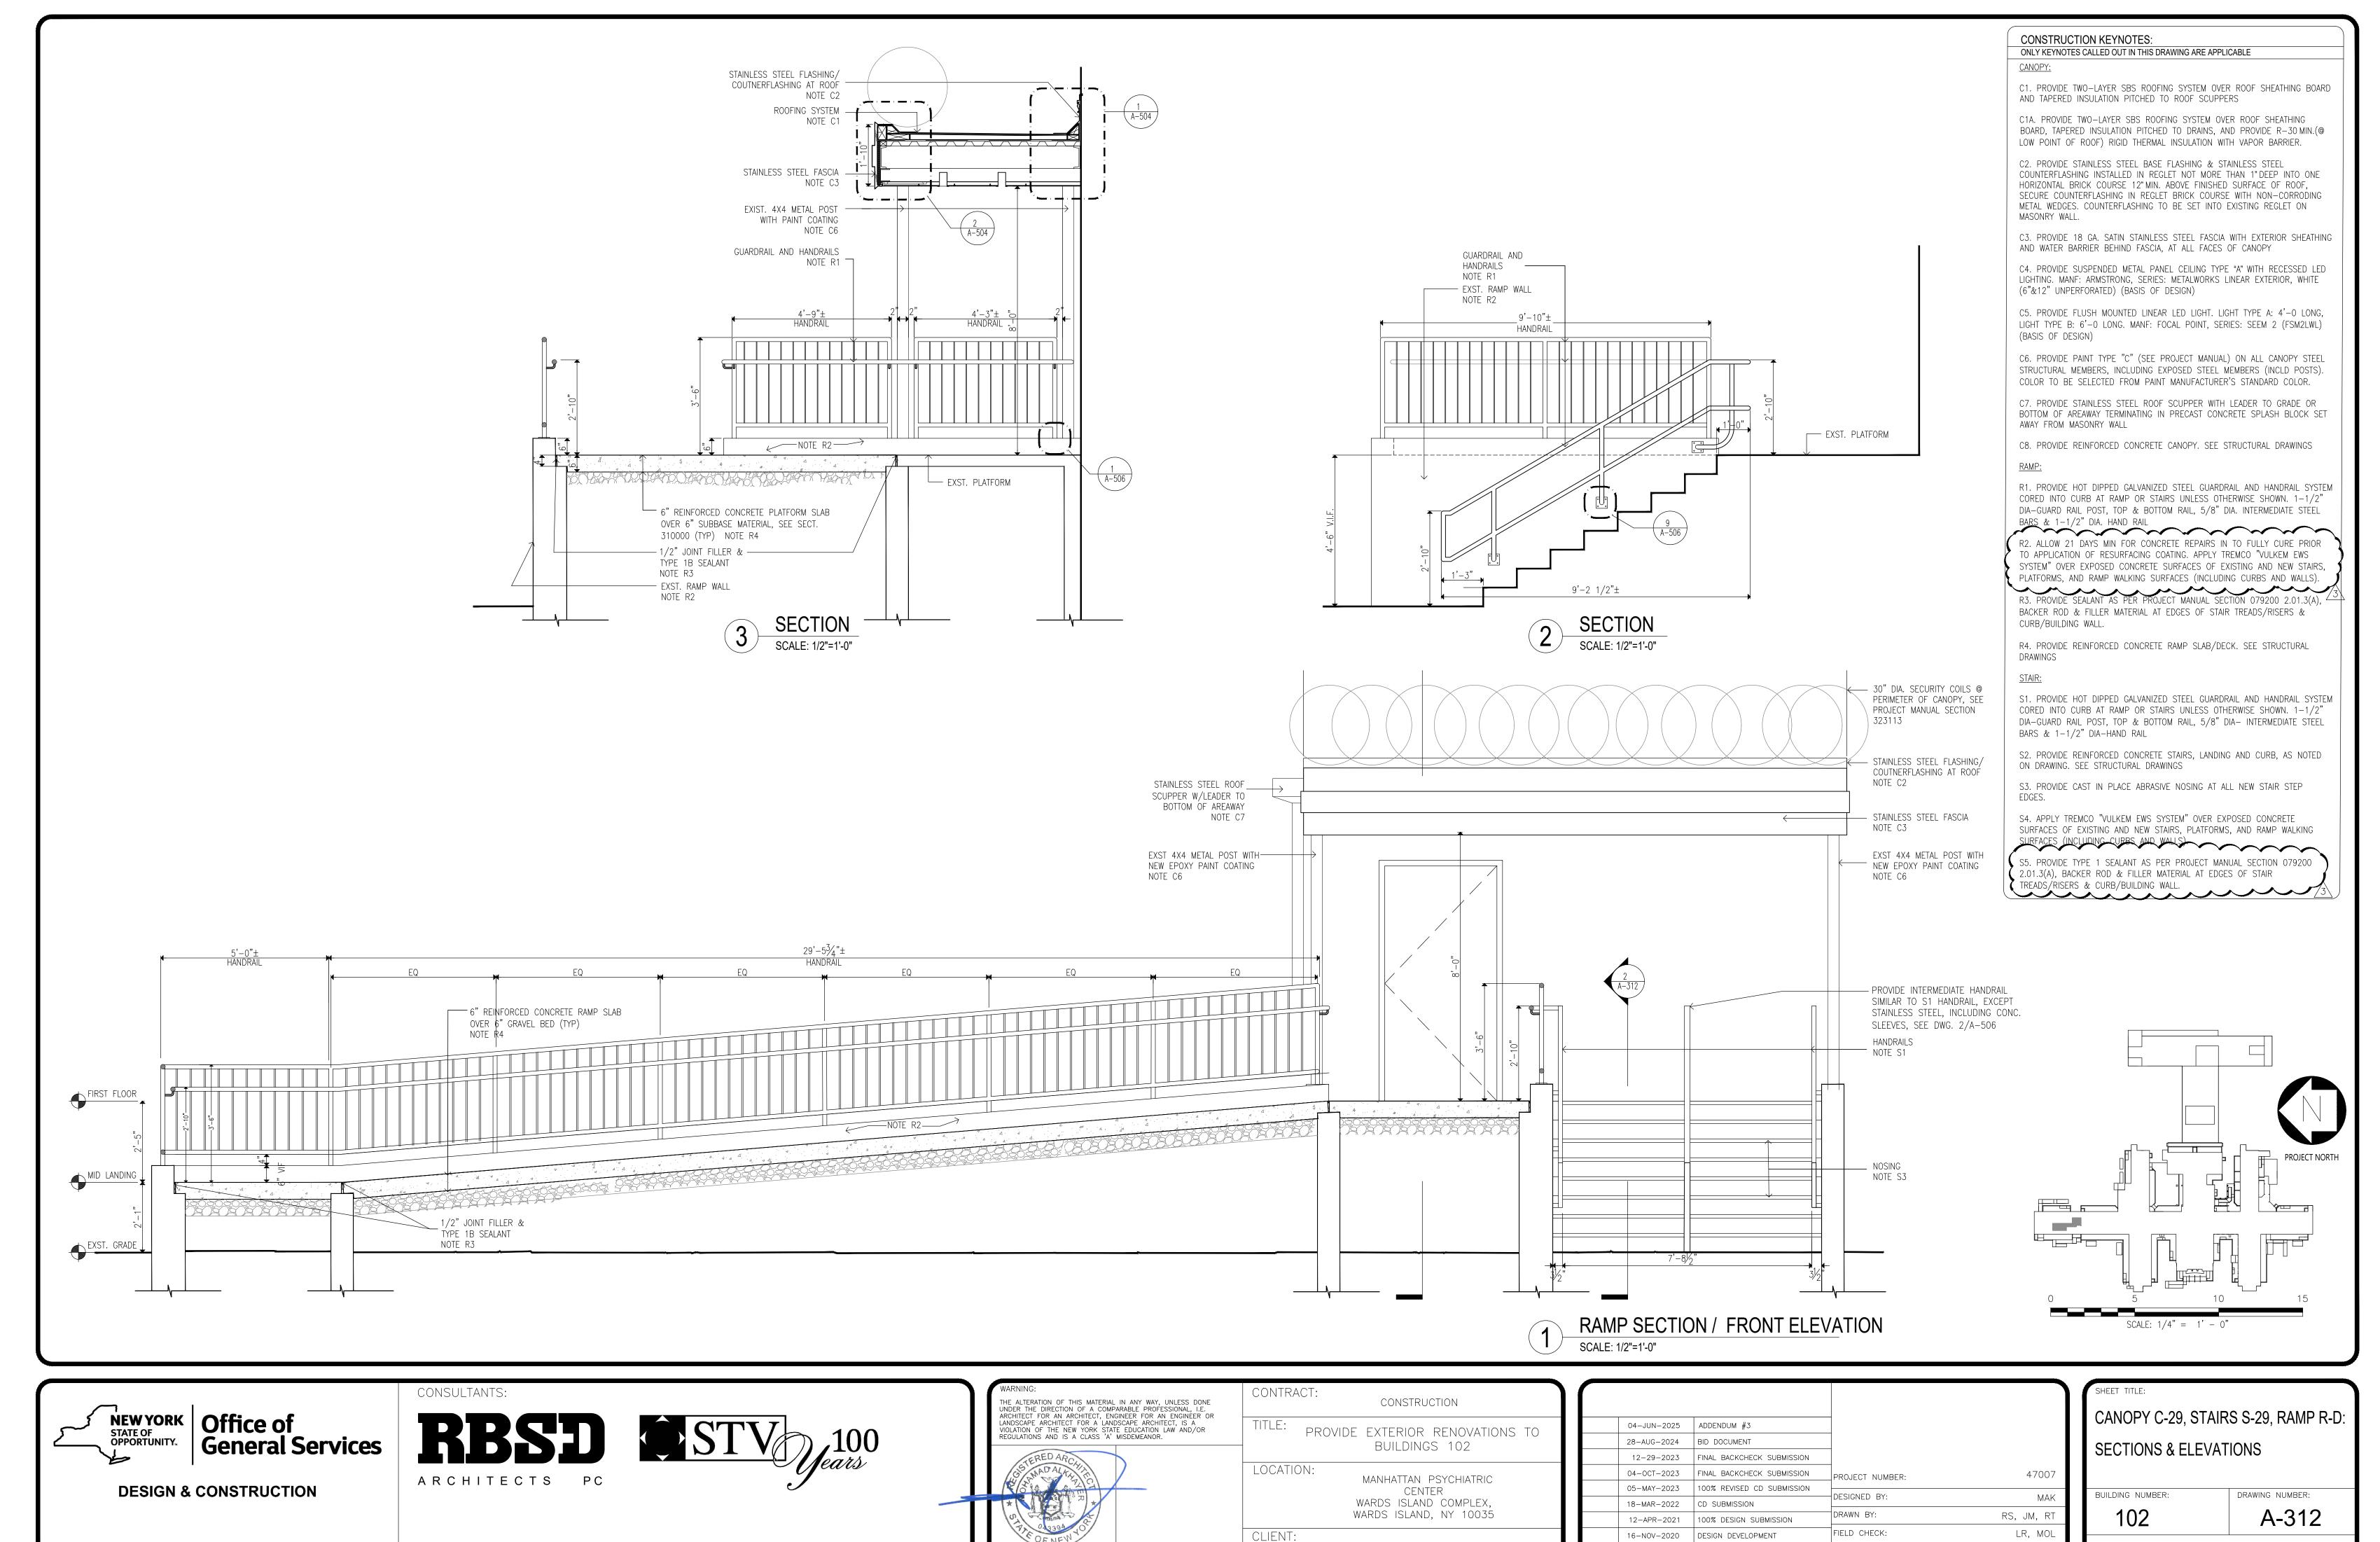

NYS OFFICE OF MENTAL HEALTH

MAK


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THE ALTERATION OF THIS MATERIAL IN ANY WAY, UNLESS DONE UNDER THE DIRECTION OF A COMPARABLE PROFESSIONAL, I.E. ARCHITECT FOR AN ARCHITECT, ENGINEER FOR AN ENGINEER OR	CONTRACT: CONSTRUCTION		
LANDSCAPE ARCHITECT FOR A LANDSCAPE ARCHITECT, IS A VIOLATION OF THE NEW YORK STATE EDUCATION LAW AND/OR REGULATIONS AND IS A CLASS 'A' MISDEMEANOR.	TITLE: PROVIDE EXTERIOR RENOVATIONS TO BUILDINGS 102		
TERED ARC	BUILDINGS 102		
S MAD ALAZIZATION	LOCATION:  MANHATTAN PSYCHIATRIC  CENTER		
* C1220A	WARDS ISLAND COMPLEX, WARDS ISLAND, NY 10035		
ARCH. REGISTRATION EXPIRES: 06-30-26	CLIENT:  NYS OFFICE OF MENTAL HEALTH		

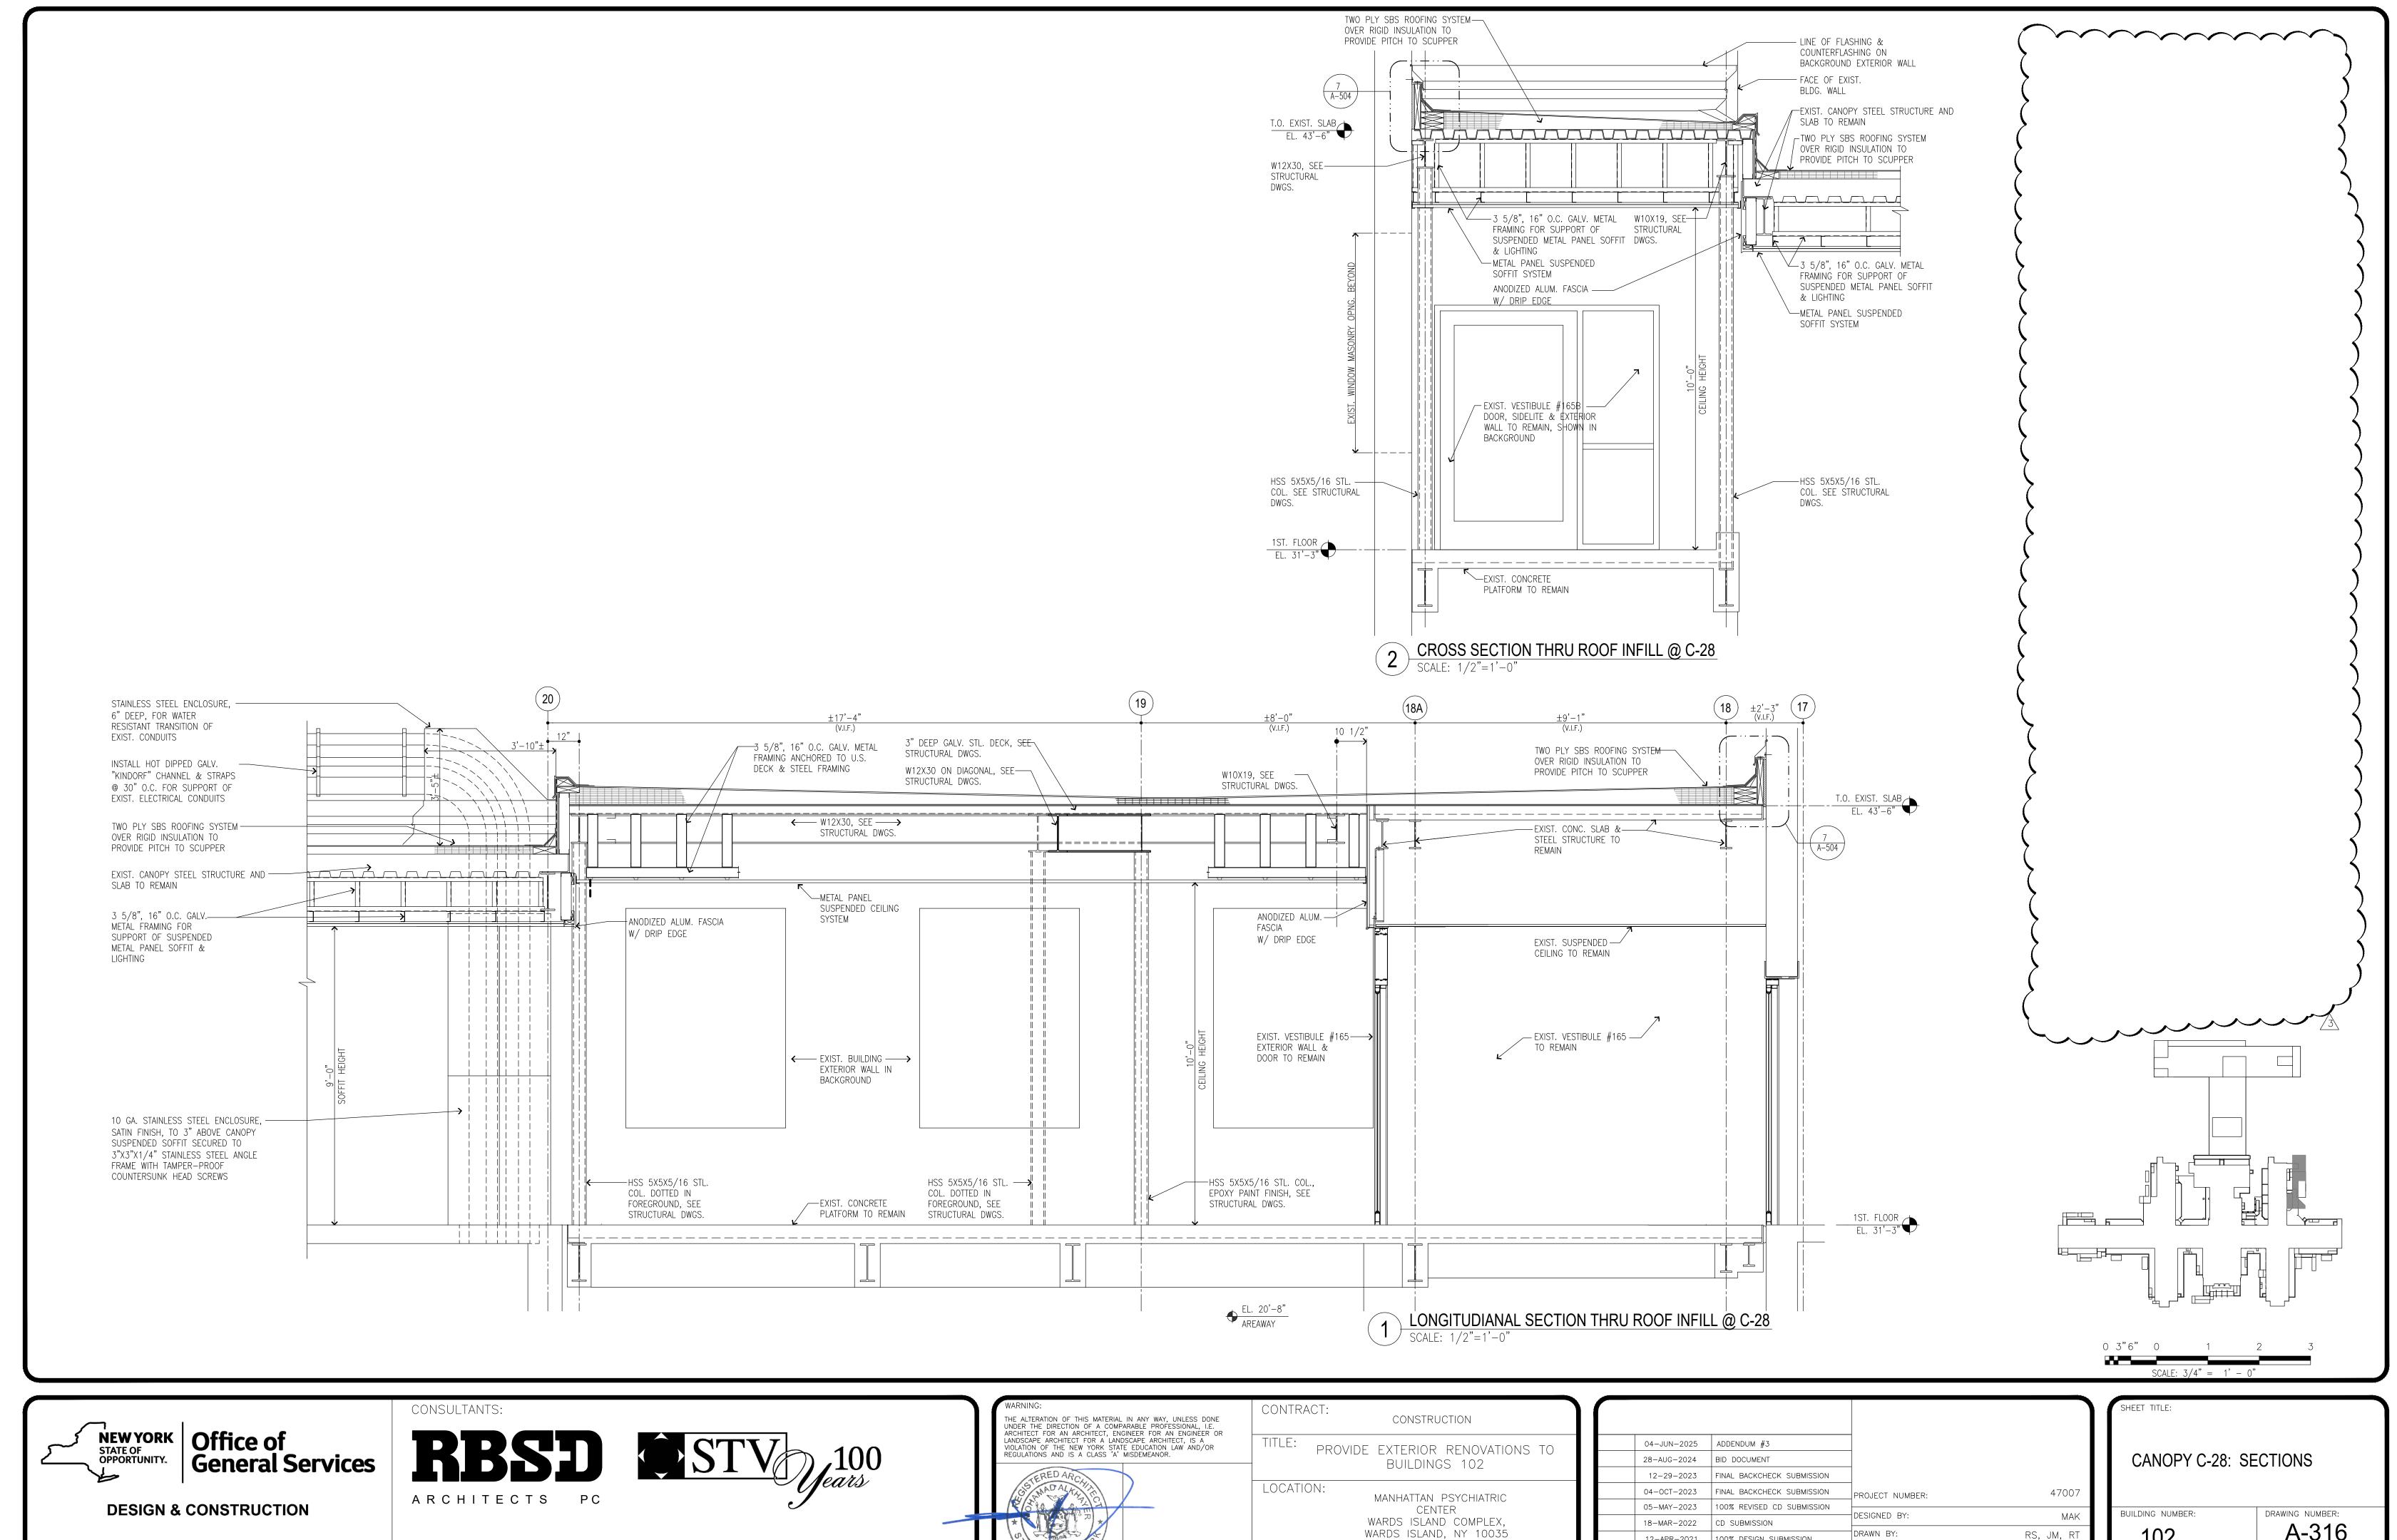	04-JUN-2025	ADDENDUM #3		
	28-AUG-2024	BID DOCUMENT		
	12-29-2023	FINAL BACKCHECK SUBMISSION		
	04-OCT-2023	FINAL BACKCHECK SUBMISSION	  PROJECT_NUMBER:	47007
	05-MAY-2023	100% REVISED CD SUBMISSION	DECIONED DV.	NANZ
	18-MAR-2022	CD SUBMISSION	DESIGNED BY:	MAK
	12-APR-2021	100% DESIGN SUBMISSION	DRAWN BY:	RS, JM, RT
	16-NOV-2020	DESIGN DEVELOPMENT	FIELD CHECK:	LR, MOL
MARK	DATE	DESCRIPTION	APPROVED:	MAK

	SCALE: 3/4" = 1' - 0"			
1	SHEET TITLE:			
	CANOPY C-28: SECTIONS			
	0/ 11 (0/ 11 (0/ 20))			
	BUILDING NUMBER:	DRAWING NUMBER:		
		A-316		
	102	Λ-310		
	SHEET			






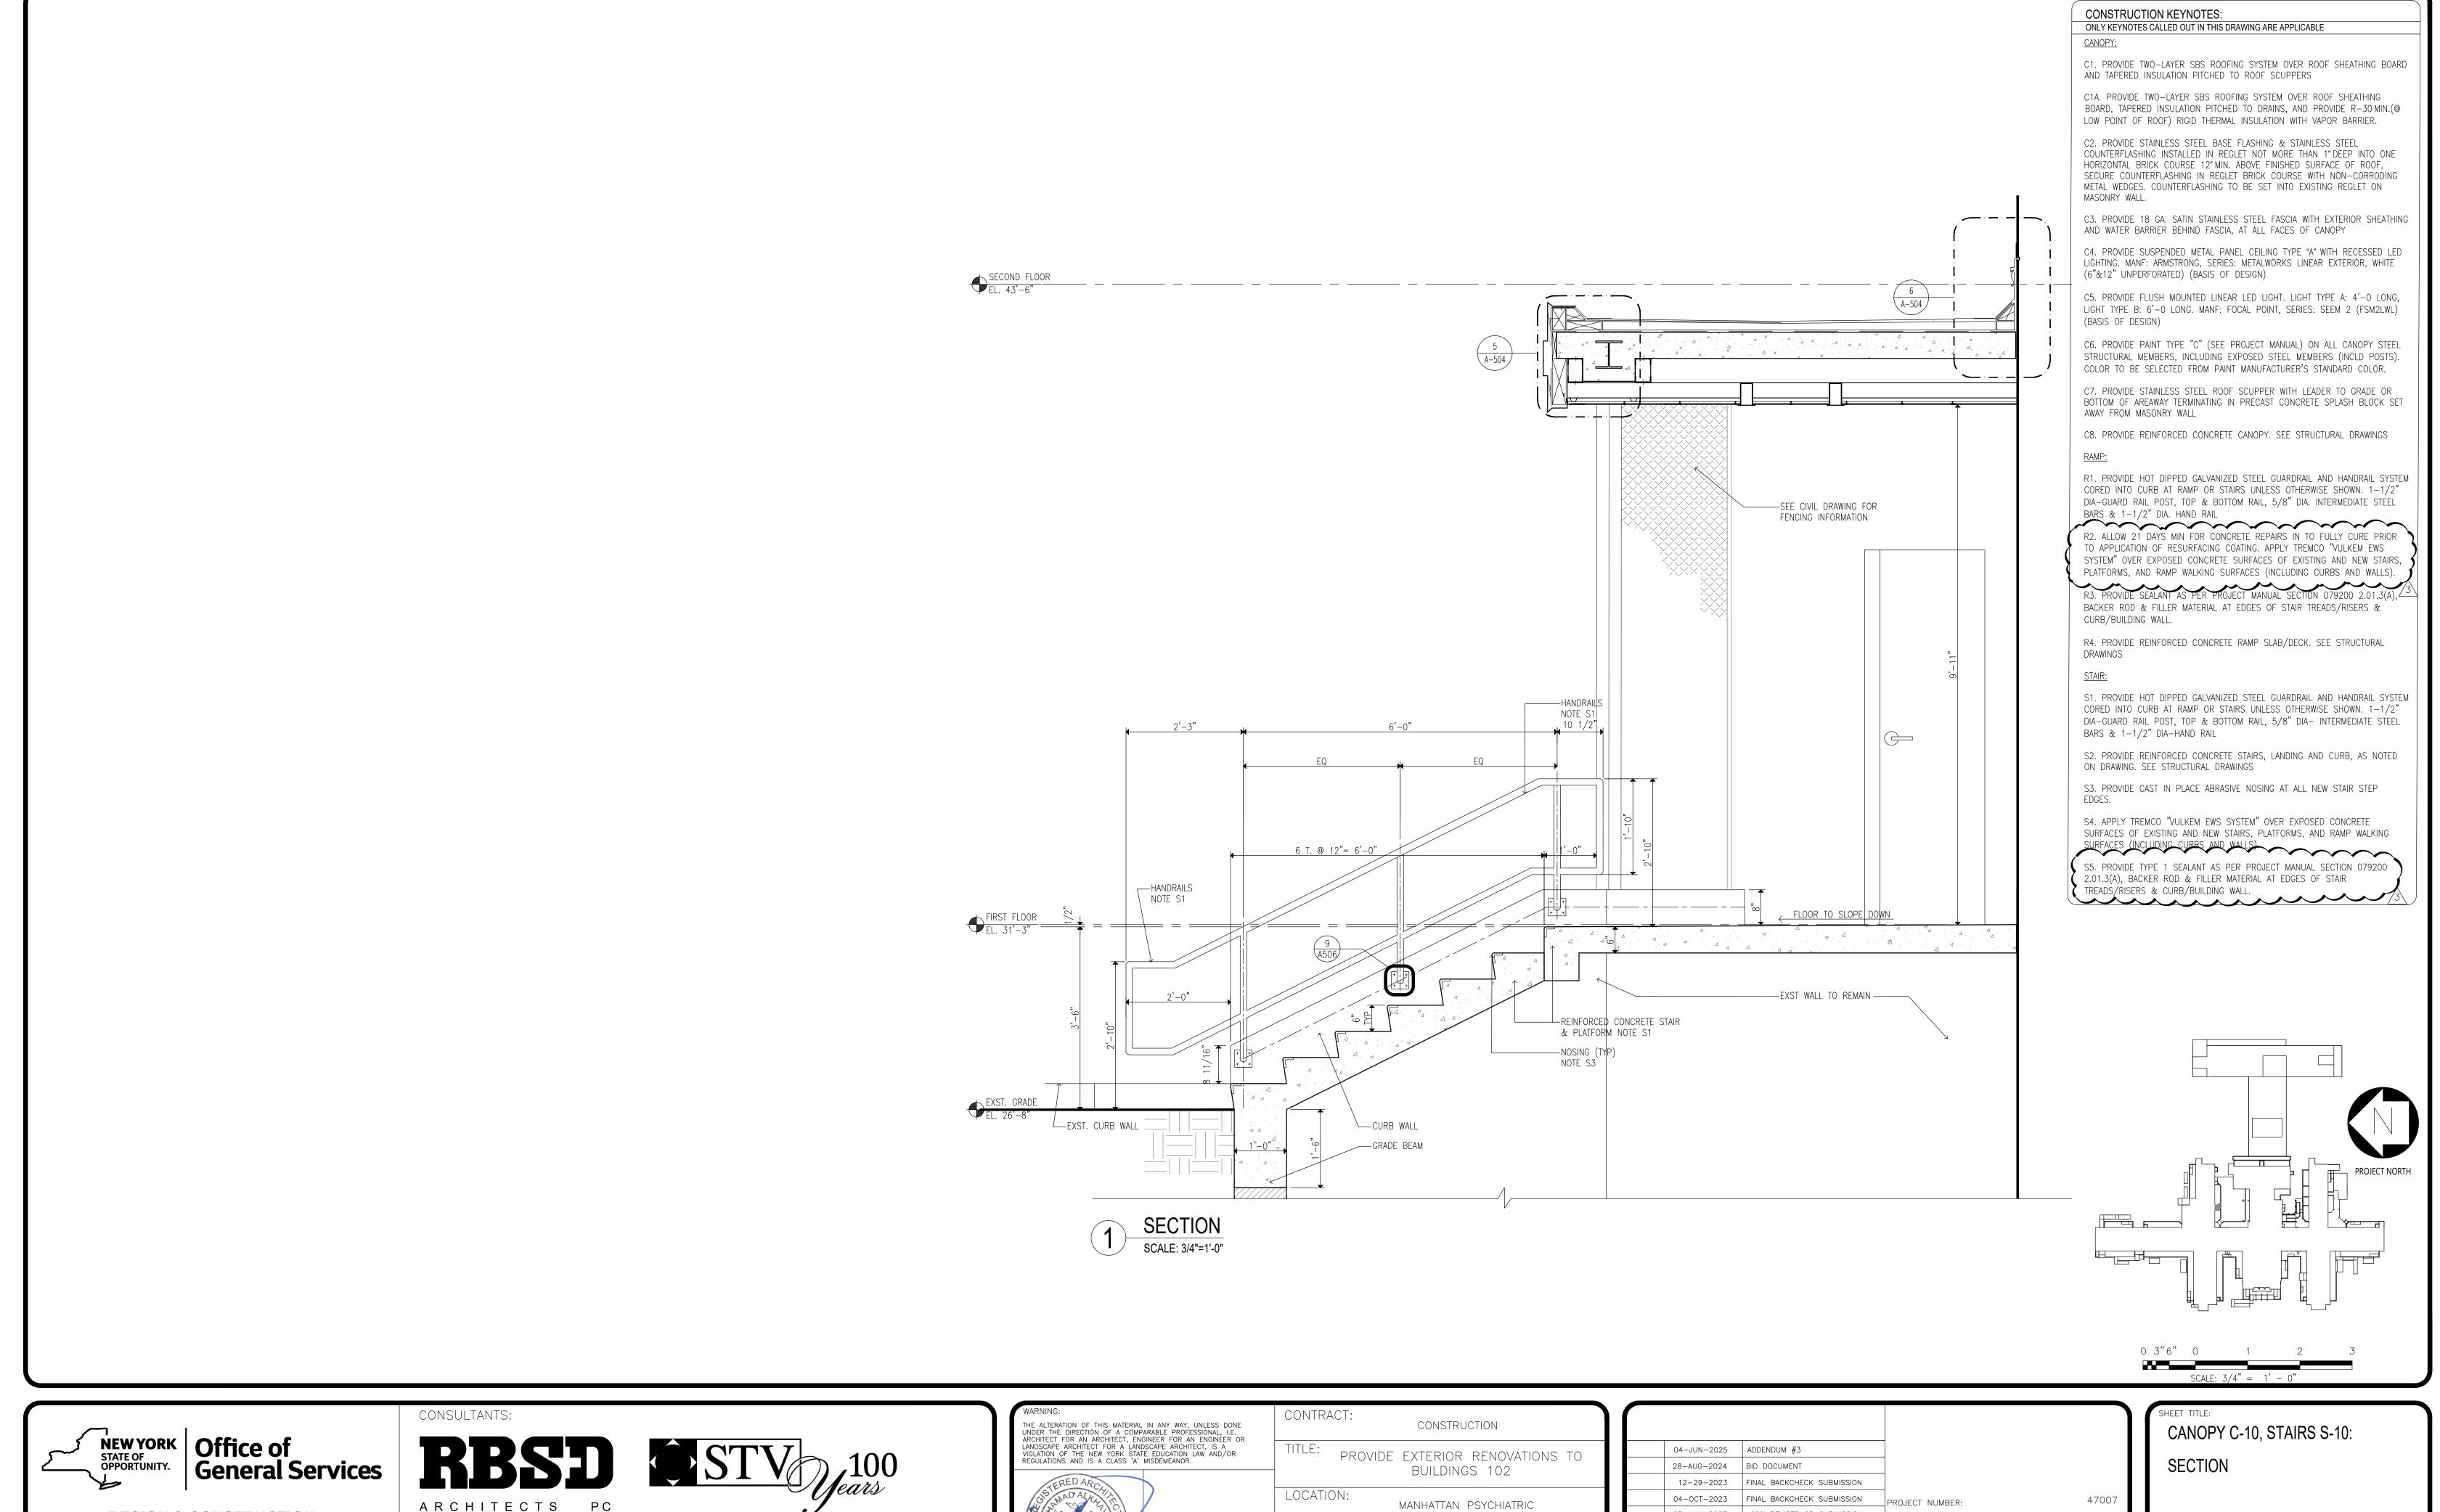

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LANDSCAPE ARCHITECT FOR A LANDSCAPE ARCHITECT, IS A VIOLATION OF THE NEW YORK STATE EDUCATION LAW AND/OR REGULATIONS AND IS A CLASS 'A' MISDEMEANOR.	TITLE: PROVIDE EXTERIOR RENOVATIONS TO BUILDINGS 102		
STERED ARCHITIC	LOCATION:  MANHATTAN PSYCHIATRIC  CENTER		
* O 23394 O	WARDS ISLAND COMPLEX, WARDS ISLAND, NY 10035		
ARCH. REGISTRATION EXPIRES: 06-30-26	CLIENT:  NYS OFFICE OF MENTAL HEALTH		

	04-JUN-2025	ADDENDUM #3			
	28-AUG-2024	BID DOCUMENT			
	12-29-2023	FINAL BACKCHECK SUBMISSION			
	04-OCT-2023	FINAL BACKCHECK SUBMISSION	PROJECT NUMBER:	47007	
	05-MAY-2023	100% REVISED CD SUBMISSION	DECIONED DV		
	18-MAR-2022	CD SUBMISSION	DESIGNED BY:	MAK	
	12-APR-2021	100% DESIGN SUBMISSION	DRAWN BY:	RS, JM, RT	
	16-NOV-2020	DESIGN DEVELOPMENT	FIELD CHECK:	LR, MOL	$\vdash$
MARK	DATE	DESCRIPTION	APPROVED:	MAK	S

SCALE: $3/4" = 1' - 0"$	
CANOPY C-10, STAI	RS S-10:
BUILDING NUMBER:	DRAWING NUMBER:
102	A-318
SHFFT	

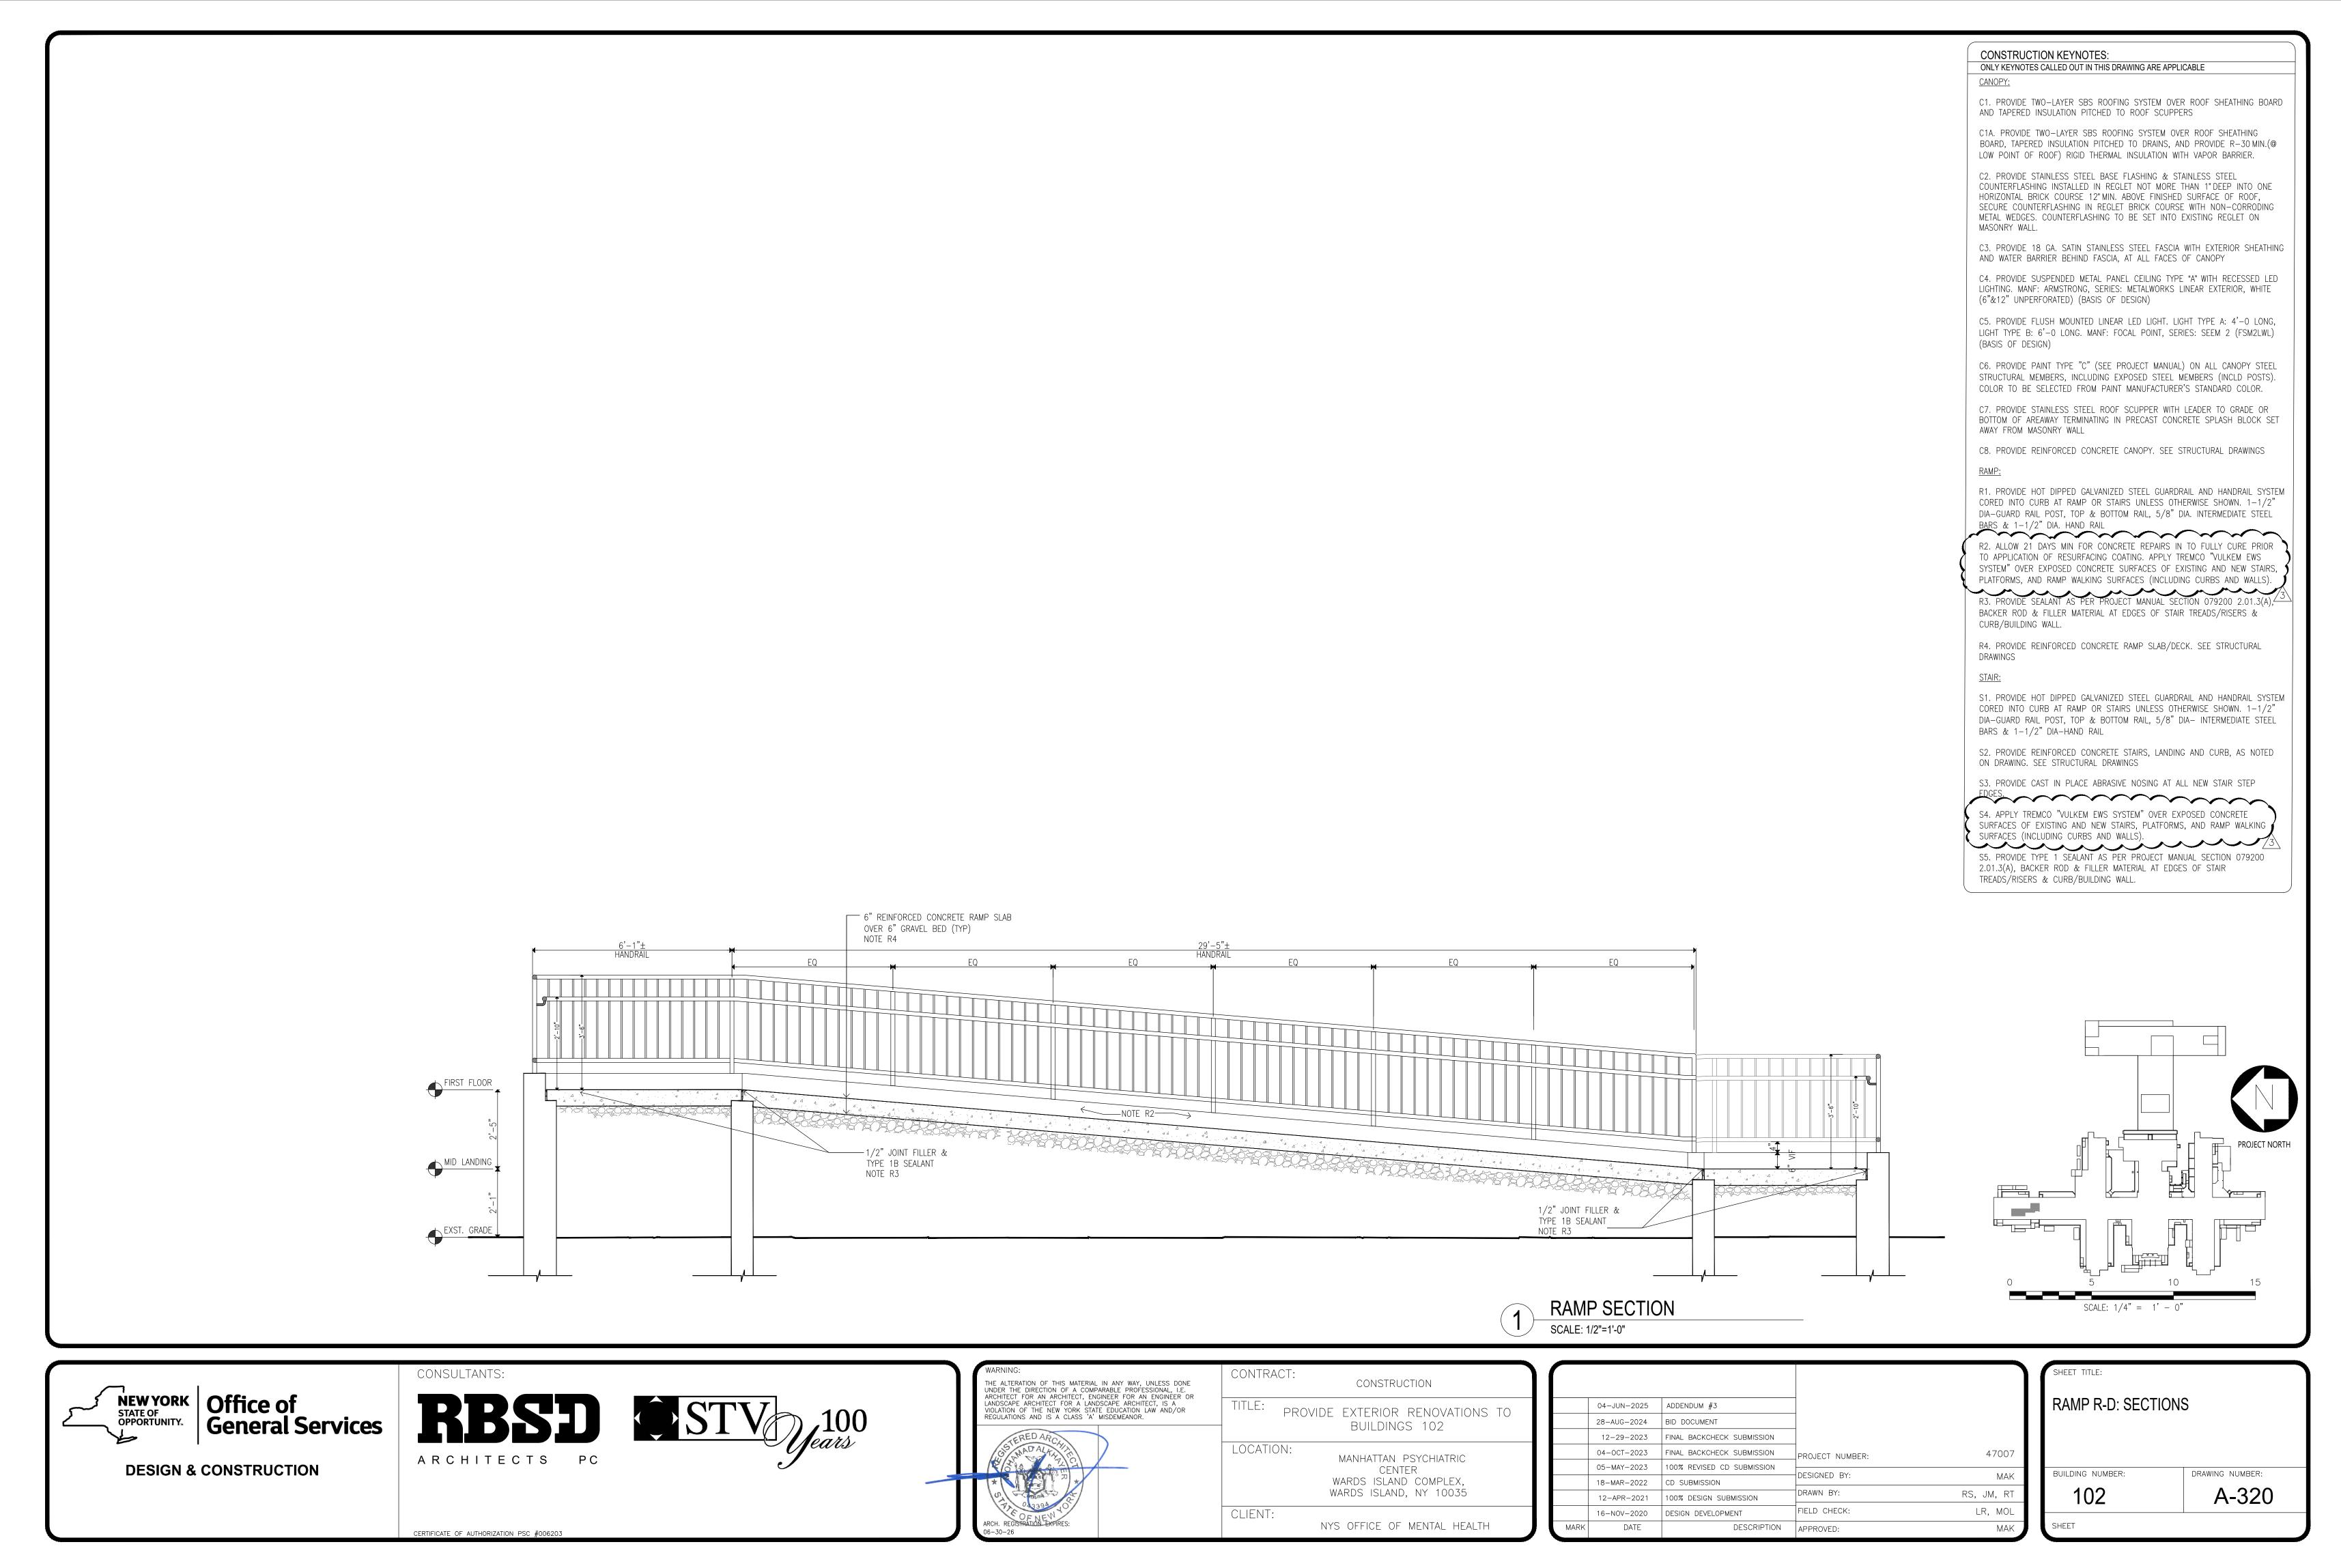

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		R	ELAY PANEL RP-BA	
RELAY SPACE NO.	RELAY POLES	BRANCH CIRCUIT NO.	LOAD & ROOM NO.	CONTROL TYPE
а	1	DP-CRA-2	YARD A/B FLOOD LIGHTING	D,T
b	1	LP-BA-2	YARD A - EXT POLE MOUNT SITE LIGHTING	D,T
С	1		SPARE	
d	1	LP-BA-4	YARD A - PAVILION LIGHTING	D,T
е	1		SPARE	
f	1	LP-BA-6	YARD A - FLOOD LIGHTING	D,T
g	1	LP-BA-7	SWING YARD - EXT POLE MOUNT LTG	D,T
h	1	LP-BA-8	EXTERIOR BUILDING MOUNTED LTG	D,T
i	1		SPARE	
j	1	LP-BA-10	EXTERIOR BUILDING MOUNTED LTG	D,T
k	1	LP-BA-20	CORRIDOR 005A, 005A-3	T,M
	1	LP-BA-20	CORRIDOR 006A, RM 031A, 032A	T,M
m	1	LP-BA-21	CORRIDOR 002A, 003A, 012A	T,M
n	1	LP-BA-21	ELEVATOR LOBBY 004A	T,O
0	1	LP-BA-23	ELEVATOR LOBBY 000B	T,M
р	1	LP-BA-23	ELEVATOR LOBBY 000B	T,M
q	1	LP-BA-23	CORRIDOR 007B, 007B-1	T,M
r	1	LP-BA-24	CORRIDOR 005B	T,M
S	1	LP-LSBA-6	EXTERIOR N/E LTG	D,T
t	1	LP-LSBA-1	EXTERIOR N/E LTG	D,T
u	1	LP-LSBA-2	EXTERIOR N/E LTG	D,T
V	1	LP-LSBA-3	EXTERIOR N/E LTG	D,T
W	1	LP-LSBA-4	EXTERIOR N/E LTG	D,T
Х	1	LP-LSBA-5	EXTERIOR N/E LTG	D,T
У	1	LP-BA-24	CORRIDOR 006B-1	T,M
Z	1	LP-BA-24	CORRIDOR 030B	T,M
aa	1	LP-BA-21	CORRIDOR 001A	T,M
bb	1	LP-BA-25	CORRIDOR 006B-2	T,M
CC	1		SPARE	
dd	1		SPARE	
ee	1		SPARE	
ff	1		SPARE	
99	1		SPARE	
hh	1		SPARE	
ii	1		SPARE	
jj	1		SPARE	
	P-30A TACTOR	DP-CRA-3	EXTERIOR SECURITY FENCE LIGHTING	D,T

	LIGHT FIXTURE SCHEDULE				
SYMBOL TYPE	DESCRIPTION	LAMP	FIXTURE WATTS	VOLT	MANUFACTURER & CATALOG NO.
A	NARROW EXTRUDED ALUMINUM 2.5" APERTURE RECESSED SLOT LED, NOMINAL 4' 33W SUITABLE FOR WET LOCATIONS. LOCATIONS: CANOPIES	LINEAR LED	5-33W	277	SEEM 2, FSM2LWL, OR APPROVED EQUAL
В	NARROW EXTRUDED ALUMINUM 2.5" APERTURE RECESSED SLOT LED, NOMINAL 6' 33W SUITABLE FOR WET LOCATIONS. LOCATIONS: CANOPIES	LINEAR LED	5-33W	277	SEEM 2, FSM2LWL, OR APPROVED EQUAL
	HANDRAIL LIGHTING SYSTEM, STANDARD HOUSING LENGTH 6', FIELD CUTTABLE	LED	100W MAX	277	WAGNER "LUMENPOST 28" LED LIGHTING MODULE OR APPROVED EQUAL
C LAMP POST	ROUND ALUMINUM NON-TAPERED POLE MOUNT, 10'-0" SIZE ON POST TOP, FLUSH MOUNTS, BLACK MATTE TEXTURED	LED	28-138W	$\zeta$	KIM LIGHTING, UR20-EDGE LIT. UR20-192L-135-5KT-5W-UNV-FM44- BLT-7PR OR APPROVED EQUAL LIGHT POLE: PRA-10-4125-FM-BLT
X5b □□─	POLE MOUNT, 20" SIZE ON POST TOP, FIXTURE HOUSING SHALL BE DIE-CAST ALUMINUM ALLOY. PROVIDE WITH DIE CAST HEAT SINK WITH POWDER COATED FINISH. PROVIDE WITH TOOL-LESS DOOR HARDWARE. ALL HARDWARE SHALL BE STAINLESS STEEL OR CORROSION RESISTANT.	LED	226W	277	COOPER LIGHTING MCGRAW-EDISON #GLEON-SA2C-740-2-T3 OR APPROVED EQUAL
С	LAY-IN TROFFER 2'x4' LIGHT FIXTURE, COLOR TEMPERATURE AT 4000K, ANTI-GLARE WHITE TRANSLUCENT ACRYLIC, 80CRI	LED	35W		ALCON LIGHTING 14150-24-4000K OR APPROVED EQUAL
D	LITHONIA FRAME FLAT 2'x2' PANEL, 4000LM, 4000K	LED	30.6W	120- 277V	LITHONIA LIGHTING LFRM-2X2-4000K-MVOLT OR APPROVED EQUAL
E	LITHONIA FRAME FLAT 2'x4' PANEL, 4000LM, 4000K	LED	37.9W	120- 277V	LITHONIA LIGHTING LFRM-2X4-4000K-MVOLT OR APPROVED EQUAL
F	LITHONIA EPANL SERIES 1'x4' LED EDGE-LIT FLAT PANEL, 1500LM, 80CRI, 4000K. ACCESSORIES: DRYWALL GRID ADAPTOR FOR 1x4 RECESSED FIXTURE	LED	14W	120- 277V	LITHONIA LIGHTING EPANL-1X4-1500LM-80CRI-40K-MVOLT OR APPROVED EQUAL

## **GENERAL NOTES:**

- 1. SEE DRAWING E-001 FOR GENERAL NOTES.
- 2. THE CONTRACTOR SHALL FIELD VERIFY THE EXISTING CONDITIONS AND BRING TO THE ATTENTION OF THE ENGINEER ANY DISCREPANCIES.



**DESIGN & CONSTRUCTION** 

CONSULTANTS: RBSD ARCHITECTS PC



WARNING: THE ALTERATION OF THIS MATERIAL IN ANY WAY, UNLESS DO	CONTRACT: CONSTRUCTION
UNDER THE DIRECTION OF A COMPARABLE PROFESSIONAL, I.I ARCHITECT FOR AN ARCHITECT, ENGINEER FOR AN ENGINEER LANDSCAPE ARCHITECT FOR A LANDSCAPE ARCHITECT, IS A VIOLATION OF THE NEW YORK STATE EDUCATION LAW AND/O REGULATIONS AND IS A CLASS 'A' MISDEMEANOR.	PROVIDE EXTERIOR RENOVATIONS,
E OF NEW	BUILDING 102 & 106
* LICONIO	LOCATION:  MANHATTAN PSYCHIATRIC  CENTER  WARDS ISLAND COMPLEX,  WARDS ISLAND, NY
POFESSIONAL	CLIENT:  NYS OFFICE OF MENTAL HEALTH

	17 JUNE 2025	ADDENDUM 3		
	28 AUG 2024	BID DOCUMENT		
	29 DEC 2023	FINAL BACKCHECK SUBMISSION		
	04 OCT 2023	FINAL BACKCHECK SUBMISSION	PROJECT NUMBER:	47007-C
	05 MAY 2023	100% CD REVISED SUBMISSION		
	18 MAR 2022	100% CD SUBMISSION	DESIGNED BY:	HS
	12 APR 2021	100% DESIGN SUBMISSION	DRAWN BY:	NS
	16 NOV 2020	DESIGN DEVELOPMENT	FIELD CHECK:	HS
MARK	DATE	DESCRIPTION	APPROVED:	FK

ELECTRICAL LIGHTING PANEL SCHEDULE AND LIGHTING FIXTURE SCHEDULE		
BUILDING NUMBER: 102	DRAWING NUMBER: E-701	
SHFFT		